# TOWN OF NEEDHAM MASSACHUSETTS 2023 FEB -7 PM 12: 53

500 Dedham Avenue Needham, MA 02492

617-455-7550

# PLANNING BOARD

# APPLICATION FOR SITE PLAN REVIEW

Y X	Majo	or Project
·	Mino	or Project
This application must be completed, signed representative in accordance with the Plann Special Permit Granting Authority. Section	ing Board'	itted with the filing fee by the applicant or his s Rules as adopted under its jurisdiction as a by-laws.
Location of Property: <u>589 Highland Aver</u>	nue, Needh	am, MA 02494
Name of Applicant: Wingate Developm	ent LLC	
Address: 63 Kendrick Street, Needham, MA	02494	Tel.#: _781 707 9209
Applicant is Owner Tenant	I	Purchaser Agent/Attorney X
Property Owner's Name: Wingate at Needh	nam, Inc.	
Address: 63 Kendrick Street, Needham, MA	02494	Геl.#:
Characteristics of Property: Lot Area:	110,490 sq	. ft. Present Use: Nursing Home
Map #: 77 Parcel #: 1		Zoning District: Elder Services Zoning Distric
Description of Project for Site Plan Review	under Sect	ion 7.4. of the Zoning By-law:
existing Special Permit, to convert the then- Units. The Nursing Home was officially clos with the work and change of use authorized	current Nu sed on or a by that am	approved an application for an amendment to the rsing Home to 50 Independent Living ("IL") bout April 21, 2022. Applicant intends to proceed endment.
which will add another 22 IL units, for a total affordable as defined in the Elder Services Deno other use is proposed for the site. Major F	al of 72 IL District byla Project Site at Living is	units, of which 12.5%, or 9 units, will be aw. As with the previously approved amendment, a Plan Review and an amendment to the existing an SP use in the Elder Services District, and
The prior Nursing Home use was ap July 27, 1993, as amended by decisions date 2011, and December 17, 2013 (Minor Chang	d August 9	Site Plan Special Permit Decision No. 93-3 dated 9, 1994; August 8, 1995, June 3, 1997, March 15,
Signature of Applicant (or his repres	entative)	Evans Huber, Esq.
Address if not Applicant		Frieze Cramer Rosen & Huber LLP 62 Walnut Street, Suite 6, Wellesley, MA 02481
Owner's permission if other than app	olicant	Tel: 781/943 4000
Received by Planning Board		NG BOARD ACTION Date 9 3 23
Hearing Date		
Decision Required by	(date)	Parties in Interest Notified
(90 days after hearing for special permit)		of Public Hearing(date)
Granted	_(date)	Decision and Notices of the Decision sent(date)
Denied	_(date)	Fee Paid
Withdrawn	_(date)	Fee Paid Fee Waived

NOTE: Reports on Minor Projects must be issued within 35 days of filing date.

# Frieze Cramer Rosen & Huber LLP

COUNSELLORS AT LAW

62 WALNUT STREET, SUITE 6, WELLESLEY, MASSACHUSETTS 02481
781-943-4000 • FAX 781-943-4040

February 3, 2023

## Via Electronic Mail and Hand Delivery

Members of the Needham Planning Board

And

Lee Newman
Director of Planning and Community Development
Public Services Administration Building
500 Dedham Ave
Needham, MA 02492

Re: 589 Highland Ave, Needham, Application for Amendment to Special Permit

Dear Planning Board Members and Ms. Newman:

I am writing on behalf of Wingate Development LLC and Wingate at Needham, Inc., with respect to the property at 589 Highland Avenue in Needham. The original Planning Board Decision authorizing the nursing home use at this site, Site Plan Special Permit 93-3 dated July 27, 1993, was amended on August 9, 1994; August 8, 1995; June 3, 1997; March 15, 2011; and December 17, 2013 (Minor change). By Decision dated March 15, 2022, this Board approved an application for an amendment to the existing Special Permit, to convert the then-current Nursing Home to 50 Independent Living ("IL") Units. The Nursing Home was officially closed on or about April 21, 2022.

The original decision and amendments are collectively referred to herein as the "Special Permit."

Pursuant to Chapter 40A of the Massachusetts General Laws, the Needham Zoning By-Law, the Needham Planning Board Rules, and Section 4.2 of the Special Permit, the Applicant, Wingate Development LLC, and the Owner, Wingate at Needham, Inc., hereby submit an application, of which this letter is a part, requesting that the Special Permit be further amended as described below.

The property is a 2.536-acre parcel (110,489 square feet) located at the corner of Highland Avenue and Gould Street. The property is located in the Elder Services zoning district and is currently improved with a two-story brick building that housed, until April 21, 2022, a 142-bed skilled nursing facility. At the moment the building is vacant.

The Applicant and Owner intend to proceed with the work and change of use authorized by the March 15, 2022 Amendment to the Special Permit, converting the building to 50 IL units. As an expansion to that project, Applicant now proposes to add a third floor to the building, which will add another 22 IL units, for a total of 72 IL units, of which 12.5%, or 9 units, will be affordable as defined in the Elder Services District bylaw. As with the previously approved amendment, all 72 units will consist of studios, 1-bedroom and 2-bedroom apartments with full kitchens and washers and dryers. No other use is proposed for the site.

Per section 3.12.9 of the Bylaw, the parking requirement for IL units is .5 spaces per unit, resulting in a required parking supply for this proposed redevelopment of 36 spaces. Wingate also anticipates 6 full time employees which would require an additional 3 spaces (1 space per 2 employees). The additional parking requirement would bring the total required to 39 spaces.

As shown on the site layout and landscaping plans submitted herewith, there are currently 98 spaces on site. Applicant proposes to eliminate 17 parking spaces on the side of the building opposite Gould Street, to create more green space and landscaping and to eliminate head-in parking immediately adjacent to the first-floor units on that portion of the building. The proposed number of spaces on this site will therefore be 81, so that there will be more than sufficient existing parking to satisfy the bylaw requirement, and, indeed, one parking space per unit (plus staff spaces) rather than the .5 spaces per unit (plus staff spaces) required by the Bylaw. By prior special permit, permission was granted to count 10 spaces on the adjacent property (known as "Lot A") towards the required parking total. However, because the required parking supply for this proposal is so much lower than the available supply on this lot (known as "Lot B"), it is no longer be necessary to count those spaces on the adjacent property as part of the available parking supply.

Please note that as indicated on the zoning table located on the site plan filed herewith, the building, including the proposed third floor, complies with all dimensional and setback requirements, and the parking areas comply with all dimensional and other requirements of section 5.1.3 of the Zoning Bylaw.

Also please note that, per the traffic analysis submitted herewith, the proposed total of 72 independent living units will generate less traffic during all time periods than the previously-existing 142-bed nursing facility. On a typical weekday, the independent living units will generate a total of 200 fewer vehicle trips (entering and exiting), including fewer trips during the morning and afternoon peak hours. On Saturdays, it is expected that the independent living units will likewise generate 27 fewer trips during the peak hour than the previously-existing facility.

Pursuant to Section 3.12.10 of the Zoning By-Law, at least 10% of the IL Apartments are required to be Affordable Housing Units. However, as noted above, in this instance the Applicant is agreeing that, consistent with the previously expressed preference of the Board, twelve and one-half percent (12.5%) of the units will be Affordable. Since the combination of the previously-approved project and the current proposal includes the creation of seventy-two (72) IL Apartments, a total of nine (9) will be designated as Affordable Housing Units.

Major Project Site Plan Review and an amendment to the existing Special Permit is sought because Independent Living is an SP use in the Elder Services District, and because the proposed third floor will require construction in excess of 10,000 square feet. The zoning relief required for this proposal is approval pursuant to the Site Plan Review process, and an Amendment to the existing Special Permit to allow an increase from the previously-approved 50 IL units, to 72 IL units, in accordance with the plans, drawings, and renderings submitted herewith. Various aspects of the existing Special Permit, as currently amended, will become moot as a result. No other zoning relief is required, because, as noted above and in the zoning and parking tables filed herewith, the proposed building will comply with all dimensional and setback requirements in the Bylaw, and the parking areas will comply with all dimensional and other requirements of section 5.1.3 of the Zoning Bylaw.

With respect to the floor plans, the Applicant reserves the right to revise said floor plans without the need for additional hearings or approvals, provided that the total square footage of the building does not increase, and the total number of IL units does not exceed seventy-two (72).

The Applicant certifies pursuant to the Zoning By-Law, Section 7.4 that the project can be constructed and/or that the proposed uses thereof can be commenced without need for the issuance of any variance from any provisions of the Zoning By-Law by the Zoning Board of Appeals.

This Application for Site Plan Review and Amendment to Special Permit includes the following documents:

- 1. This letter dated February 3, 2023 to the Planning Board and Planning Director.
- 2. Another letter from this office, also dated February 3, 2023, discussing how this project meets the Site Plan Review criteria in the Bylaw.
- 3. The completed application form signed by myself on behalf of the applicant, and by the owner of the property, Wingate at Needham, Inc.
- 4. Traffic Analysis prepared by Ron Muller & Associates, 56 Teresa Road, Hopkinton, MA 01748, dated January 25, 2023.

- 5. Engineering Plans (including zoning table) for 589 Highland Avenue, Wingate Needham, Needham Mass, dated February 3, 2023, prepared by Kelly Engineering Group, 0 Campanelli Drive, Braintree, MA 02184. Note that these plans include an existing conditions site plan, dated February 3, 2023, prepared by R.E. Cameron & Associates, Inc., 681 Washington Street, Norwood, MA 02062.
- 6. Stormwater management report, dated February 3, 2023 prepared by Kelly Engineering Group, 0 Campanelli Drive, Braintree, MA 02184.
- 7. Landscaping Plans February 3, 2023, prepared by Hawk Design Inc., P.O. Box 1309, Sandwich, MA 02563.
- 8. Floor plans, unit plans, elevations and renderings dated February 3, 2023, prepared by The Architectural Team, Inc., 50 Commandant's Way, Chelsea, MA 02150.
- 9. Application fee payable to the Town of Needham in the amount of \$8,129.50.

Pursuant to the Board's Covid-19 procedures, these documents are being submitted electronically; additionally two (2) hard copies of the application (1 with original signatures) and all supporting materials, including wet-stamped plans, are being hand delivered to the Planning Department along with the application fee; and, lastly, one hard copy of items 1 through 8, above (all the plans 11 x 17), is being mailed to each Board member, and to Lee Newman.

The Applicant hereby requests, pursuant to Zoning By-Law Section 7.4.4, that the Planning Board waive the submission by Applicant of any of the required information not submitted herewith.

I would appreciate your scheduling this matter for hearing at the Board's March 7, 2023 meeting, if possible. Thank you for your cooperation.

Evans Huber

Sincerely,

# FRIEZE CRAMER ROSEN & HUBER LLP

COUNSELLORS AT LAW

62 WALNUT STREET, SUITE 6, WELLESLEY, MASSACHUSETTS 02481 781-943-4000 • FAX 781-943-4040

February 3, 2023

## Via Electronic Mail and Overnight Mail

Members of the Needham Planning Board

And

Lee Newman
Director of Planning and Community Development
Public Services Administration Building
500 Dedham Ave
Needham, MA 02492

Re: 589 Highland Ave, Needham, Application for Amendment to Special Permit

Dear Planning Board Members and Ms. Newman:

I am writing on behalf of Wingate Development LLC and Wingate at Needham, Inc., with respect to the property at 589 Highland Avenue in Needham, in connection with the application for amendment to the existing Special Permit, of which this letter is a part. As indicated in that application, by decision dated March 15, 2022, this Board approved an application for an amendment to the existing Special Permit, to convert the then-current Nursing Home to 50 Independent Living ("IL") Units. The Nursing Home was officially closed on or about April 21, 2022. Applicant intends to proceed with the work and change of use authorized by that amendment.

As an expansion to that project, Applicant now proposes to add a third floor to the building, which will add another 22 IL units, for a total of 72 IL units, of which 12.5%, or 9 units, will be affordable as defined in the Elder Services District bylaw.

The purpose of this letter is to address how the proposed expanded project meets the Town's Site Plan Review criteria as set forth in 7.4.6 of the Bylaw.

(a) Protection of adjoining premises against seriously detrimental uses by provision for surface water drainage, sound and sight buffers and preservation of views, light, and air.

The proposed project has been designed to protect adjoining premises from detrimental impacts as follows:

The site has been designed to ensure that there will be no off-site drainage impacts. A drainage system exists on site. The drainage system will ensure that peak storm generation levels will remain unchanged. The proposed site development plans will be presented to the Town of Needham Engineering Department. The proposed project will have a net reduction in impervious area and is exempt from the Town of Needham Stormwater Bylaw.

A landscape plan has been developed for screening and enhancing the existing site. Parking spaces up against the west side of the building have been replaced with greenspace. This eliminates the issue of automobile headlights shining into the ground floor units and provides a more attractive view for residents and abutters on that side of the building. Noise and visual impacts have been minimized. Abutting properties will be protected by means of the existing solid fence and mature trees. Shade trees proposed for the newly created greenspace will add to the landscape buffering.

(b) Convenience and safety of vehicular and pedestrian movement within the site and on adjacent streets, the location of driveway openings in relation to traffic or to adjacent streets and, when necessary, compliance with other regulations for the handicapped, minors and the elderly.

The project has been designed ensure that there will be safe vehicular and pedestrian circulation throughout the site. The access and egress to the property will be via existing driveways off Gould St. and Highland Ave. that will remain and provide access to the site. Sidewalks exist on both Gould St. and Highland Ave. that connect to the sidewalks on the site. This allows for pedestrian access to the site.

The main entrance into the building is proposed to be accessed by way of a pedestrian only seating courtyard. A two-foot high retaining/seat wall on the Highland Ave. and Gould St. side of the courtyard will allow for additional berming to help with sound attenuation. A pergola will provide shading for residents and draw attention to the main entrance for visitors. New mass plantings of shrubs, ornamental grasses and perennials will rejuvenate the slope at the intersection and help to improve the existing identity sign's visibility.

Available sight distances at the site driveways on Gould St. and Highland Ave. exceed required sight distances.

Sidewalk access has been provided adjacent to the primary parking stalls for pedestrian safety. Handicap access and parking is provided.

(c) Adequacy of the arrangement of parking and loading spaces in relation to the proposed uses of the premises.

The proposed parking area complies with the Town of Needham By Law for loading, parking, and maneuvering width in aisles. The parking is distributed throughout the site to

provide convenience for employees and visitors. Please see the Layout and Zoning Plan for additional details of the parking layout.

(d) Adequacy of the methods of disposal of refuse and other wastes resulting from the uses permitted on the site;

The site has been designed to provide for adequate methods of disposal of refuse. A dumpster enclosure exists onsite. The dumpster enclosure is screened with a wooden fence. Refuse will be removed from the site by a licensed hauler.

(e) Relationship of structures and open spaces to the natural landscape, existing buildings and other community assets in the area and compliance with other requirements of this By-Law; and

The existing building is surrounded by other senior living facilities and residential properties. The proposed building expansion is consistent with these buildings. The aforementioned fence and mature, natural landscape buffer will be maintained to the west of the site. All of the existing vegetation on the north, buffering the senior living facilities and on the east, buffering Gould St. will be preserved. To the south is a strip of existing trees and shrubs that has been impacted by the Highland Ave. bike lane construction. Shrubs are proposed to infill the disturbed areas and provide screening to the parking, and from the new courtyard to the street.

The project has been designed to maximize landscaped area and reduce impervious areas. This is accomplished by removing 17 parking spaces and the main entrance drop-off circle and replacing with landscaped areas and a small, paved seating area. Additionally, the existing sunken loading dock on the southwest corner of the building will be filled and landscaped, providing an enhanced site entry and a buffer from traffic for the ground floor residents, The open space will full comply with the requirements of the bylaw.

(f) Mitigation of adverse impacts on the Town's resources including the effect on the Town's water supply and distribution system, sewer collection and treatment, fire protection, and streets; and may require when acting as the Special Permit Granting Authority or recommend in the case of minor projects, when the Board of Appeals is acting as the Special Permit Granting Authority, such appropriate conditions, limitations, and safeguards necessary to assure the project meets the criteria of a through f.

The proposed use is expected to have minimal impacts on Town resources due to the nature of the use. It is a clean, quiet, low impact use. The project has been designed to limit adverse impacts to the Town resources as follows:

The project will maintain the existing water connection to the Town's water system. The project will maintain the existing sewer connections to the Town's sewer system by means of the connections to the sewer main located at the intersection of Highland Ave. and Gould St.

The proposed site layout plans will continue to maintain the existing access and circulation for emergency and fire protection vehicles.

Evans Huber



56 Teresa Road Hopkinton, MA 01748

Tel.: (508) 395-1576 Fax: (508) 435-2481

www.RonMullerAssociates.com

Ref.: 21044

January 25, 2023

Mr. David Feldman SVP Real Estate Development Wingate Healthcare 63 Kendrick Street Needham, MA 02494



Reg.

Proposed Wingate at Needham, Inc.

Independent Living Facility

589 Highland Avenue, Needham, MA

#### Dear David:

Ron Müller & Associates (RMA) has prepared this letter to document that conversion of the existing 142-bed skilled nursing facility into 72 independent senior living units will result in a reduction in site traffic generation. The existing building is located on Lot B at the corner of Gould Street and Highland Avenue in Needham, Massachusetts and will be renovated and expanded into independent senior living units. No change in site access or parking is proposed. This letter also documents that the demand for on-site parking will be reduced and that the supply of parking is more than adequate to accommodate the anticipated demand.

The Institute of Transportation Engineers (ITE) *Trip Generation Manual*<sup>1</sup> was used to estimate the change in traffic from the proposed conversion project. The ITE manual provides trip generation rates for nursing facilities based on the number of beds (Land Use Code 620) as well as trip generation rates for independent living facilities based on the number of units (Land Use Code 252). A summary of the expected change in traffic generation is provided in Table 1 and the trip generation worksheets are attached to this letter.

<sup>&</sup>lt;sup>1</sup> Trip Generation Manual, 11th Edition; Institute of Transportation Engineers; Washington, DC; 2021.

Table 1
Trip Generation Comparison

Time Period	Existing Skilled Nursing Facility <sup>a</sup>	Proposed Independent Living Facility <sup>6</sup>	Change in Traffic
Weekday Daily	430	230	-200
Weekday AM Peak Hour			
Enter	14	2	-12
<u>Exit</u>	$\frac{6}{20}$	13 15	<u>+7</u> -5
Total	20	15	-5
Weekday PM Peak Hour			
Enter	7	10	+3
<u>Exit</u>	<u>13</u>	<u>8</u> 18	<u>-5</u> -2
Total	1 <u>3</u> 20	18	-2
Saturday Peak Hour			
Enter	23	13	-10
<u>Exit</u>	<u>28</u>	<u>11</u>	<u>-17</u>
Total	51	24	-27

<sup>&</sup>lt;sup>a</sup> ITE Land Use Code 620 (Nursing Home) trip rates applied to 142 beds.

As shown in the table, the proposed 72 independent living units will generate less traffic during all times periods than the existing 142-bed nursing facility. On a typical weekday, the independent living units will generate 200 fewer vehicle trips (total entering and exiting traffic) of which 5 fewer trips will occur during the weekday AM peak hour (one hour between 7:00 and 9:00 AM) and 2 fewer trips will occur during the weekday PM peak hour (one hour between 4:00 and 6:00 PM). During the Saturday peak hour (typically one hour between 11:00 AM and 2:00 PM), the proposed independent living units will generate 27 fewer trips than the existing nursing facility.

The existing nursing facility building currently provides 98 parking spaces on Lot B. The proposed remodeling and reuse of the facility will eliminate 15 general-use parking spaces and two reserve spaces for a total proposed supply of 81 spaces on site. Based on parking generation rates provided in the ITE *Parking Generation* manual,<sup>2</sup> the existing nursing facility has an average peak parking demand of 62 spaces and an 85<sup>th</sup> percentile peak parking demand of 73 spaces (Land Use Code 620). Using the ITE parking generates rates for senior adult housing (Land Use Code 252), the proposed 72 independent living units will have an average peak parking demand of 44 spaces and

<sup>&</sup>lt;sup>b</sup> ITE Land Use Code 252 (Senior Adult Housing – Attached) trip rates applied to 72 units.

<sup>&</sup>lt;sup>2</sup> Parking Generation, 5<sup>th</sup> Edition; Institute of Transportation Engineers; Washington, DC; 2019.

an 85<sup>th</sup> percentile peak parking demand of 49 spaces. Accordingly, the change to independent living units will reduce the parking demand on the site and more than adequate parking will still be provided to accommodate the change in use, even with the proposed reduction in on-site spaces.

Please feel free to contact me should you have any questions regarding these estimates or conclusions.

Sincerely,

Ron Müller & Associates

Kirsten Braun, P.E.

Associate

Attachments

# Institute of Transportation Engineers (ITE); 11th Edition Land Use Code (LUC) 252 - Senior Adult Housing - Attached

Average Vehicle Trips Ends vs: Dwelling Units Independent Variable (X): 50

#### **AVERAGE WEEKDAY DAILY**

T = 2.89 \* (X) + 24.82 T = 169.32T = 170 vehicle trips

with 50% (85 vpd) entering and 50% (85 vpd) exiting.

#### WEEKDAY AM PEAK HOUR OF ADJACENT STREET TRAFFIC

T = 0.19 \* (X) + 0.90

T = 10.40

T = 10 vehicle trips

with 14% ( 1 vph) entering and 66% ( 9 vph) exiting.

## WEEKDAY PM PEAK HOUR OF ADJACENT STREET TRAFFIC

T = 0.25 \* (X) + 0.07

T = 12.57

T = 13 vehicle trips

with 56% ( 7 vph) entering and 44% ( 6 vph) exiting.

### SATURDAY DAILY

T = 2.33 \* (X) + 31.21

T = 147.71

T = 150 vehicle trips

with 50% (75 vpd) entering and 50% (75 vpd) exiting.

## SATURDAY MIDDAY PEAK HOUR OF GENERATOR

Ln T = 0.93 Ln (X) - 0.81

Ln T = 2.828

T = 16.91

T = 17 vehicle trips

with 54% (9 vph) entering and 46% (8 vph) exiting.

# WINGATE AT NEEDHAM RENOVATION / EXPANSION

589 HIGHLAND AVENUE NEEDHAM, MA.



SHEET	
NUMBER	SHEET NAME
001 - TITLE S	SHEETS
T0.01	PROJECT COVER
004 - CIVIL D	RAWINGS (UNDER SEPARATE COVER)
1	TITLE SHEET
2	SITE PLAN
3	LAYOUT PLAN
	CAPE DRAWINGS (UNDER SEPARATE COVER)
L.1	PATIO PLAN
L.2	ENTRY PLAN
L.3	PARKING / PATIO PLAN
007 - DEMOL	ITION DRAWINGS
007 - DEMOL D1.00	ITION DRAWINGS  EXISTING / DEMOLITION OVERALL PLAN - BASEMENT
D1.00 D1.01 008 - ARCHIT	EXISTING / DEMOLITION OVERALL PLAN - BASEMENT EXISTING / DEMOLITION OVERALL PLANS (SCHEMATIC)  ECTURAL - 1.00 OVERALL PLANS
D1.00 D1.01 008 - ARCHIT A1.00	EXISTING / DEMOLITION OVERALL PLAN - BASEMENT EXISTING / DEMOLITION OVERALL PLANS (SCHEMATIC)  ECTURAL - 1.00 OVERALL PLANS PROPOSED OVERALL PLAN - BASEMENT
D1.00 D1.01 008 - ARCHIT A1.00 A1.01	EXISTING / DEMOLITION OVERALL PLAN - BASEMENT EXISTING / DEMOLITION OVERALL PLANS (SCHEMATIC)  TECTURAL - 1.00 OVERALL PLANS PROPOSED OVERALL PLAN - BASEMENT PROPOSED OVERALL PLANS (SCHEMATIC)
D1.00 D1.01 008 - ARCHIT A1.00	EXISTING / DEMOLITION OVERALL PLAN - BASEMENT EXISTING / DEMOLITION OVERALL PLANS (SCHEMATIC)  TECTURAL - 1.00 OVERALL PLANS PROPOSED OVERALL PLAN - BASEMENT PROPOSED OVERALL PLANS (SCHEMATIC)
D1.00 D1.01 008 - ARCHIT A1.00 A1.01 A1.02	EXISTING / DEMOLITION OVERALL PLAN - BASEMENT EXISTING / DEMOLITION OVERALL PLANS (SCHEMATIC)  TECTURAL - 1.00 OVERALL PLANS PROPOSED OVERALL PLAN - BASEMENT PROPOSED OVERALL PLANS (SCHEMATIC)
D1.00 D1.01 008 - ARCHIT A1.00 A1.01 A1.02	EXISTING / DEMOLITION OVERALL PLAN - BASEMENT EXISTING / DEMOLITION OVERALL PLANS (SCHEMATIC)  ECTURAL - 1.00 OVERALL PLANS PROPOSED OVERALL PLAN - BASEMENT PROPOSED OVERALL PLANS (SCHEMATIC) PROPOSED OVERALL PLAN LEVEL 3 & ROOF (SCHEMATIC)
D1.00 D1.01 008 - ARCHIT A1.00 A1.01 A1.02	EXISTING / DEMOLITION OVERALL PLAN - BASEMENT EXISTING / DEMOLITION OVERALL PLANS (SCHEMATIC)  ECTURAL - 1.00 OVERALL PLANS PROPOSED OVERALL PLAN - BASEMENT PROPOSED OVERALL PLANS (SCHEMATIC) PROPOSED OVERALL PLAN LEVEL 3 & ROOF (SCHEMATIC) ECTURAL - 4.00 ELEVATIONS

SUBMISSIO

BRUARY 3, 2023 PLANNING BOARD SUBMISSION
FOR SITE PLAN REVIEW

© The Architectural Team, Inc.
50 Commandant's Way at Admiral's Hill
Chelsea MA 02150
O 617.889.4402
F 617.884.4329
architecturalteam.com

OJECT CONTACT INFORMATION :	
COLOT CONTINUON IN CINII/ CITION .	
<u> </u>	

OWNER

WINGATE AT NEEDHAM, INC.

63 KENDRICK STREET
NEEDHAM, MA 02494

THE ARCHITECTURAL TEAM

ARCHITECT

50 COMMANDANTS WAY AT ADMIRALS HILL
CHELSEA, MA 02150
PHONE #: 617.889.4402
FAX #: 617.884.4329

R.E. CAMERON & ASSOCIATES, INC.

681 WASHINGTON ST.
NORWOOD, MA 02062
PHONE #: 781.769.1777

TRANSPORTATION CONSULTANT

RON MULLER & ASSOCIATES

56 TERESA ROAD
HOPKINTON, MA 01748

CIVIL ENGINEER

KELLY ENGINEERING GROUP, INC.

0 CAMPENELLI DRIVE
BRAINTREE, MA 02184
PHONE #:
FAX #:

DSCAPE
CHITECT

HAWK DESIGN INC.

P.O. BOX 1309
SANDWICH, MA 02563
PHONE #:
FAX #:

LOCUS MAP

Consultant:

Revision:

Architect of Record



Drawn: JS

Checked: AS

Scale: Key Plan:

Project Name:

WINGATE AT NEEDHAM RENOVATION / EXPANSION

589 HIGHLAND AVENUE NEEDHAM, MA.

Sheet Name:

PROJECT COVER

Project Number:

21056

Issue Date:

FEBRUARY 3, 2023

Sheet Number:

T0.01

C:\Users\jsmith\Documents\21056\_R21\_Wingate Needham Rehabilitation\_3r

# 

© The Architectural Team, Inc. 50 Commandant's Way at Admiral's Hill Chelsea MA 02150
O 617.889.4402
F 617.884.4329
architecturalteam.com

Consultant: Revision: Architect of Record: Drawn: RP Checked: AS 3/32" = 1'-0" Scale: Key Plan: GOULD STREET Project Name: WINGATE AT NEEDHAM RENOVATION / **EXPANSION** 

589 HIGHLAND AVENUE NEEDHAM, MA.

Sheet Name:

EXISTING / DEMOLITION OVERALL PLAN -BASEMENT

Project Number:


21056

Issue Date:

FEBRUARY 3, 2023

Sheet Number:

D1.00

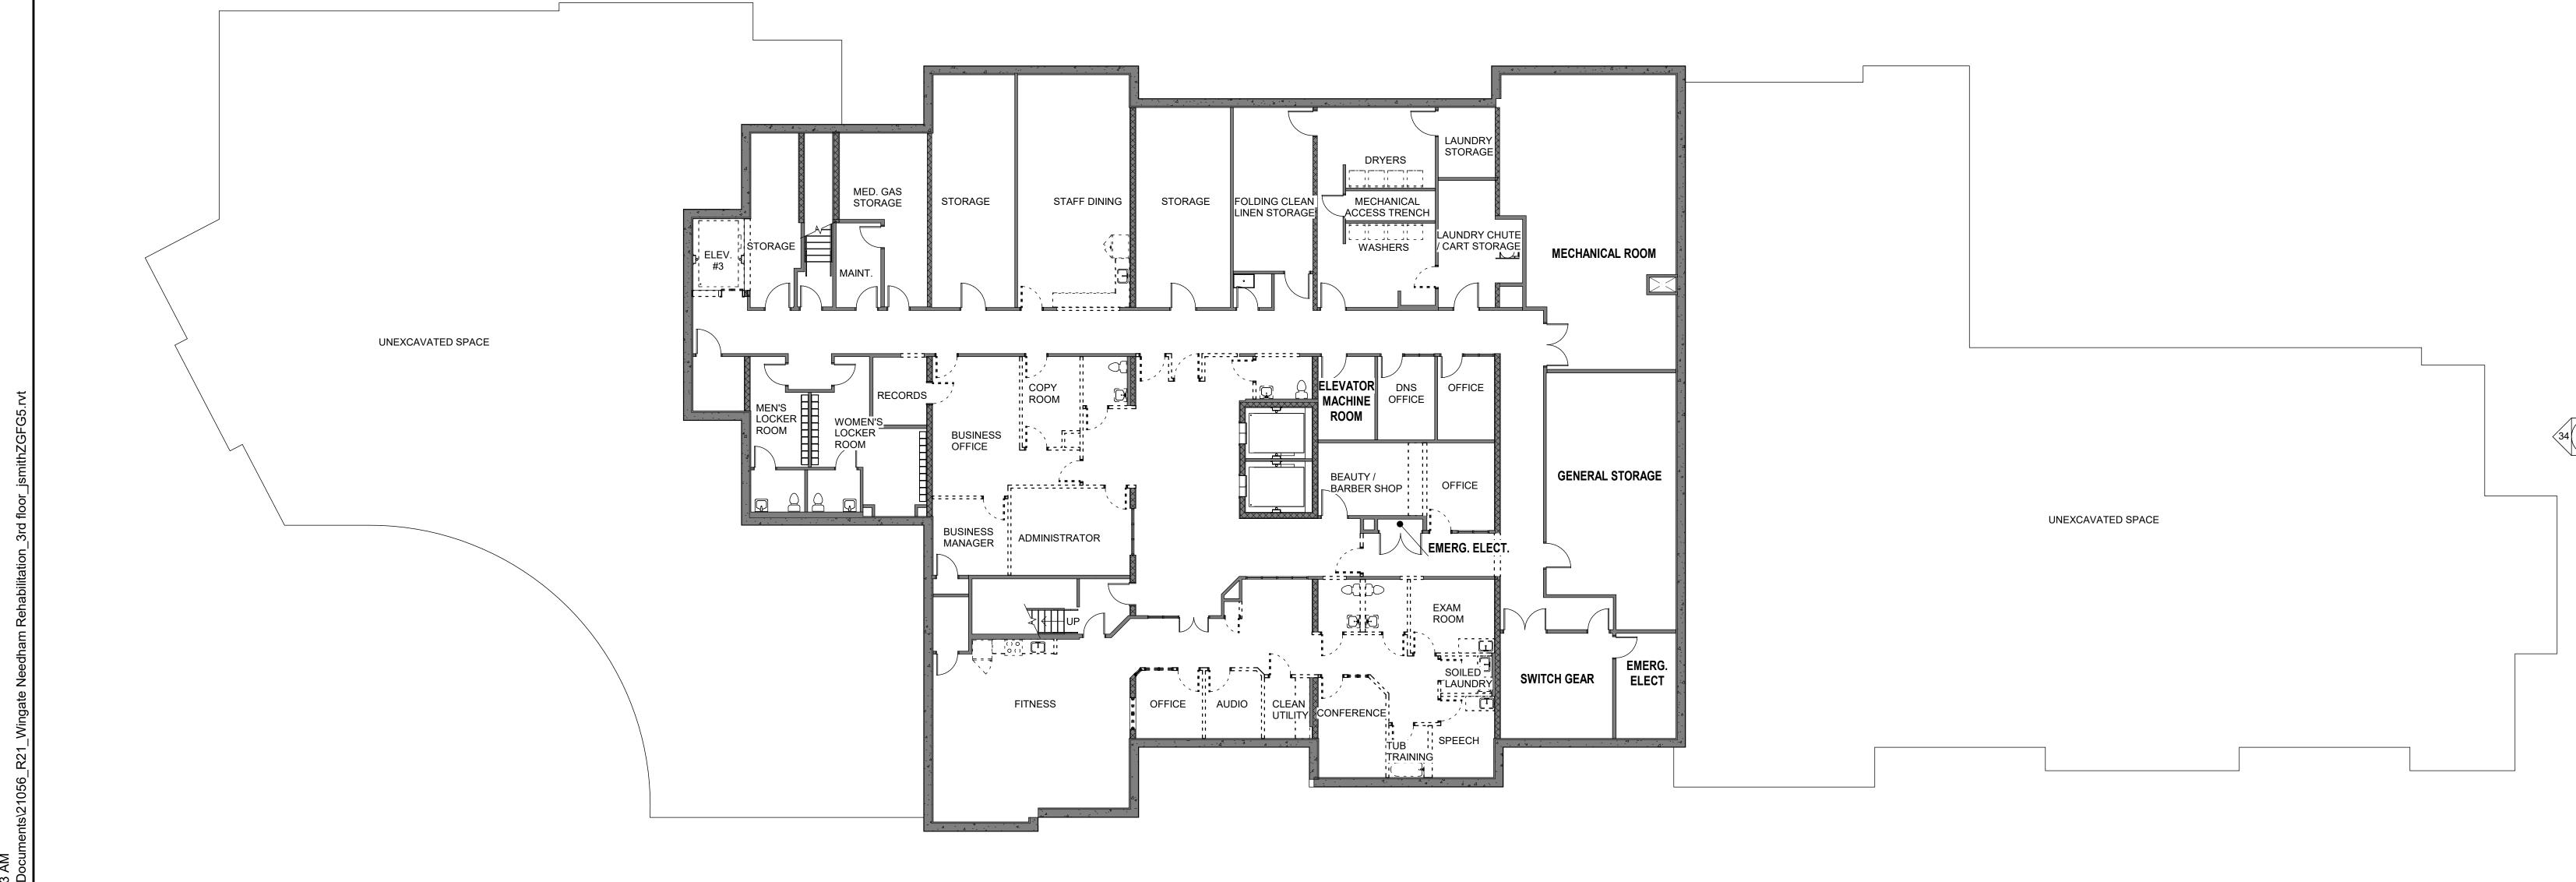


10 DEMOLITION PLAN - BASEMENT Scale: 3/32" = 1'-0"




50 Commandant's Way at Admiral's Hill

Consultant:		
Revision:		
. 13 1 10 10 11.		

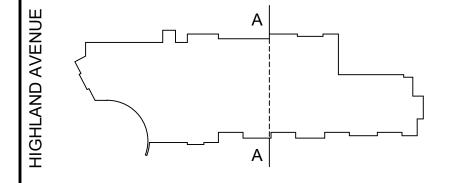

# © The Architectural Team, Inc. 50 Commandant's Way at Admiral's Hill Chelsea MA 02150 **O** 617.889.4402 **F** 617.884.4329 architecturalteam.com Consultant: Revision: Architect of Record: Drawn: JS Checked: AS 3/32" = 1'-0" Scale: Key Plan: A4.01 13 STORAGE GOLF\_ SIMULATOR MAKER SPACE STORAGE STORAGE STORAGE STORAGE STORAGE **MECHANICAL ROOM** GOULD STREET Project Name: WINGATE AT NEEDHAM SERVICE CORRIDOR RENOVATION / UNEXCAVATED SPACE **EXPANSION** ELEV. MACH. ELEVATOR MACHINE ROOM STORAGE STORAGE ELEVATOR LOBBY 589 HIGHLAND AVENUE NEEDHAM, MA. **GENERAL STORAGE** Sheet Name: UNEXCAVATED SPACE EMERG. ELECT. MEN'S TOILET WOMEN'S TOILET PROPOSED FITNESS TOILET OVERALL PLAN -STAIR #1 STORAGE BASEMENT EMERG. ELECT STORAGE SWITCH GEAR Project Number: 21056 A4.03 Issue Date: FEBRUARY 3, 2023 A4.01 A4.01 32 A4.03 31 A4.03 Sheet Number: 30 A4.03 OVERALL FLOOR PLAN - BASEMENT Scale: 3/32" = 1'-0"



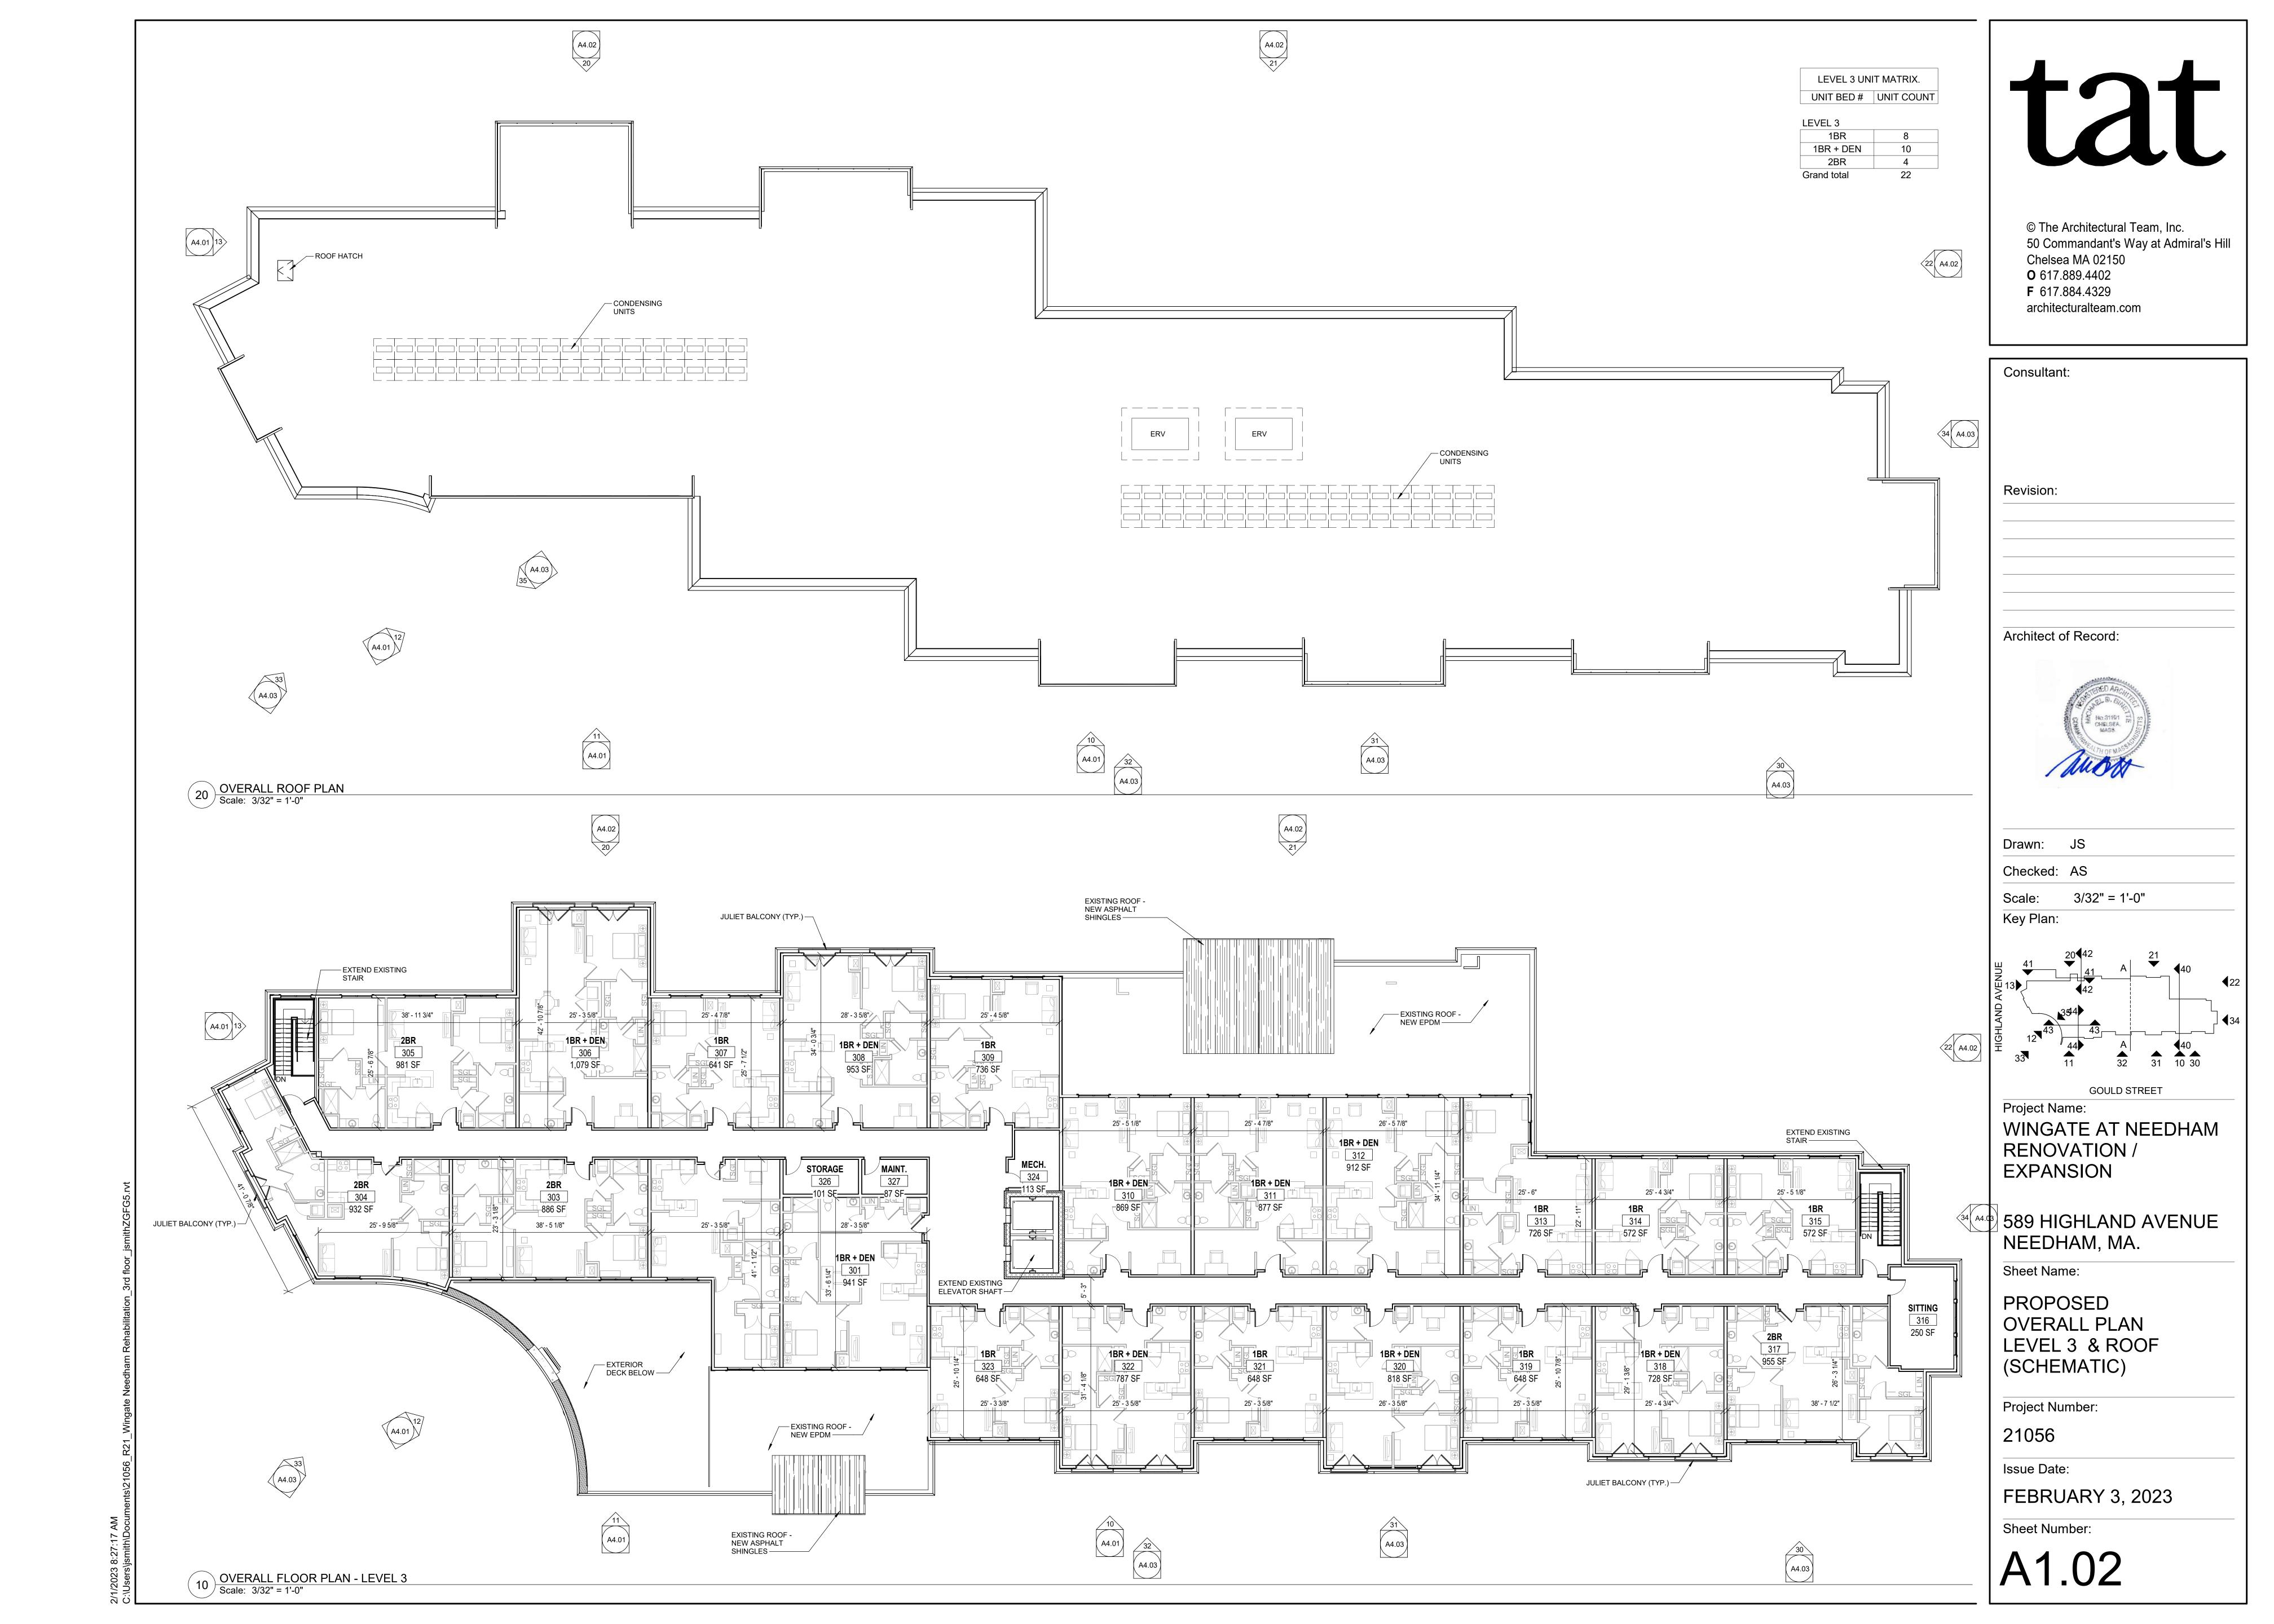



121

© The Architectural Team, Inc. 50 Commandant's Way at Admiral's Hill Chelsea MA 02150
O 617.889.4402
F 617.884.4329
architecturalteam.com

Conquitant		
Consultant:		
Revision:		
-		

Architect of Record:



Drawn:	RP
Checked:	AS
Scale:	1/8" = 1'-0"

Key Plan:

AVENUE		 A	
IIGHLAND AV	12	 Δ	 

GOULD STREET

Project Name:
WINGATE AT NEEDHAM
RENOVATION /
EXPANSION

589 HIGHLAND AVENUE NEEDHAM, MA.

Sheet Name:

EXTERIOR ELEVATIONS

Project Number:

21056

Issue Date:

FEBRUARY 3, 2023

Sheet Number:

A4.01



# tat

© The Architectural Team, Inc. 50 Commandant's Way at Admiral's Hill Chelsea MA 02150
O 617.889.4402
F 617.884.4329
architecturalteam.com

Consultant:
Revision:
Architect of Record:
HO 31191 THE SELECTION OF MASS
Drawn: RP
Checked: AS
Scale: 1/8" = 1'-0" Key Plan:
HIGHLAND AVENUE  A  The state of the state o
GOULD STREET

Project Name:
WINGATE AT NEEDHAM
RENOVATION /
EXPANSION

589 HIGHLAND AVENUE NEEDHAM, MA.

Sheet Name:

EXTERIOR ELEVATIONS

Project Number:

21056


Issue Date:

FEBRUARY 3, 2023

Sheet Number:

A4.02



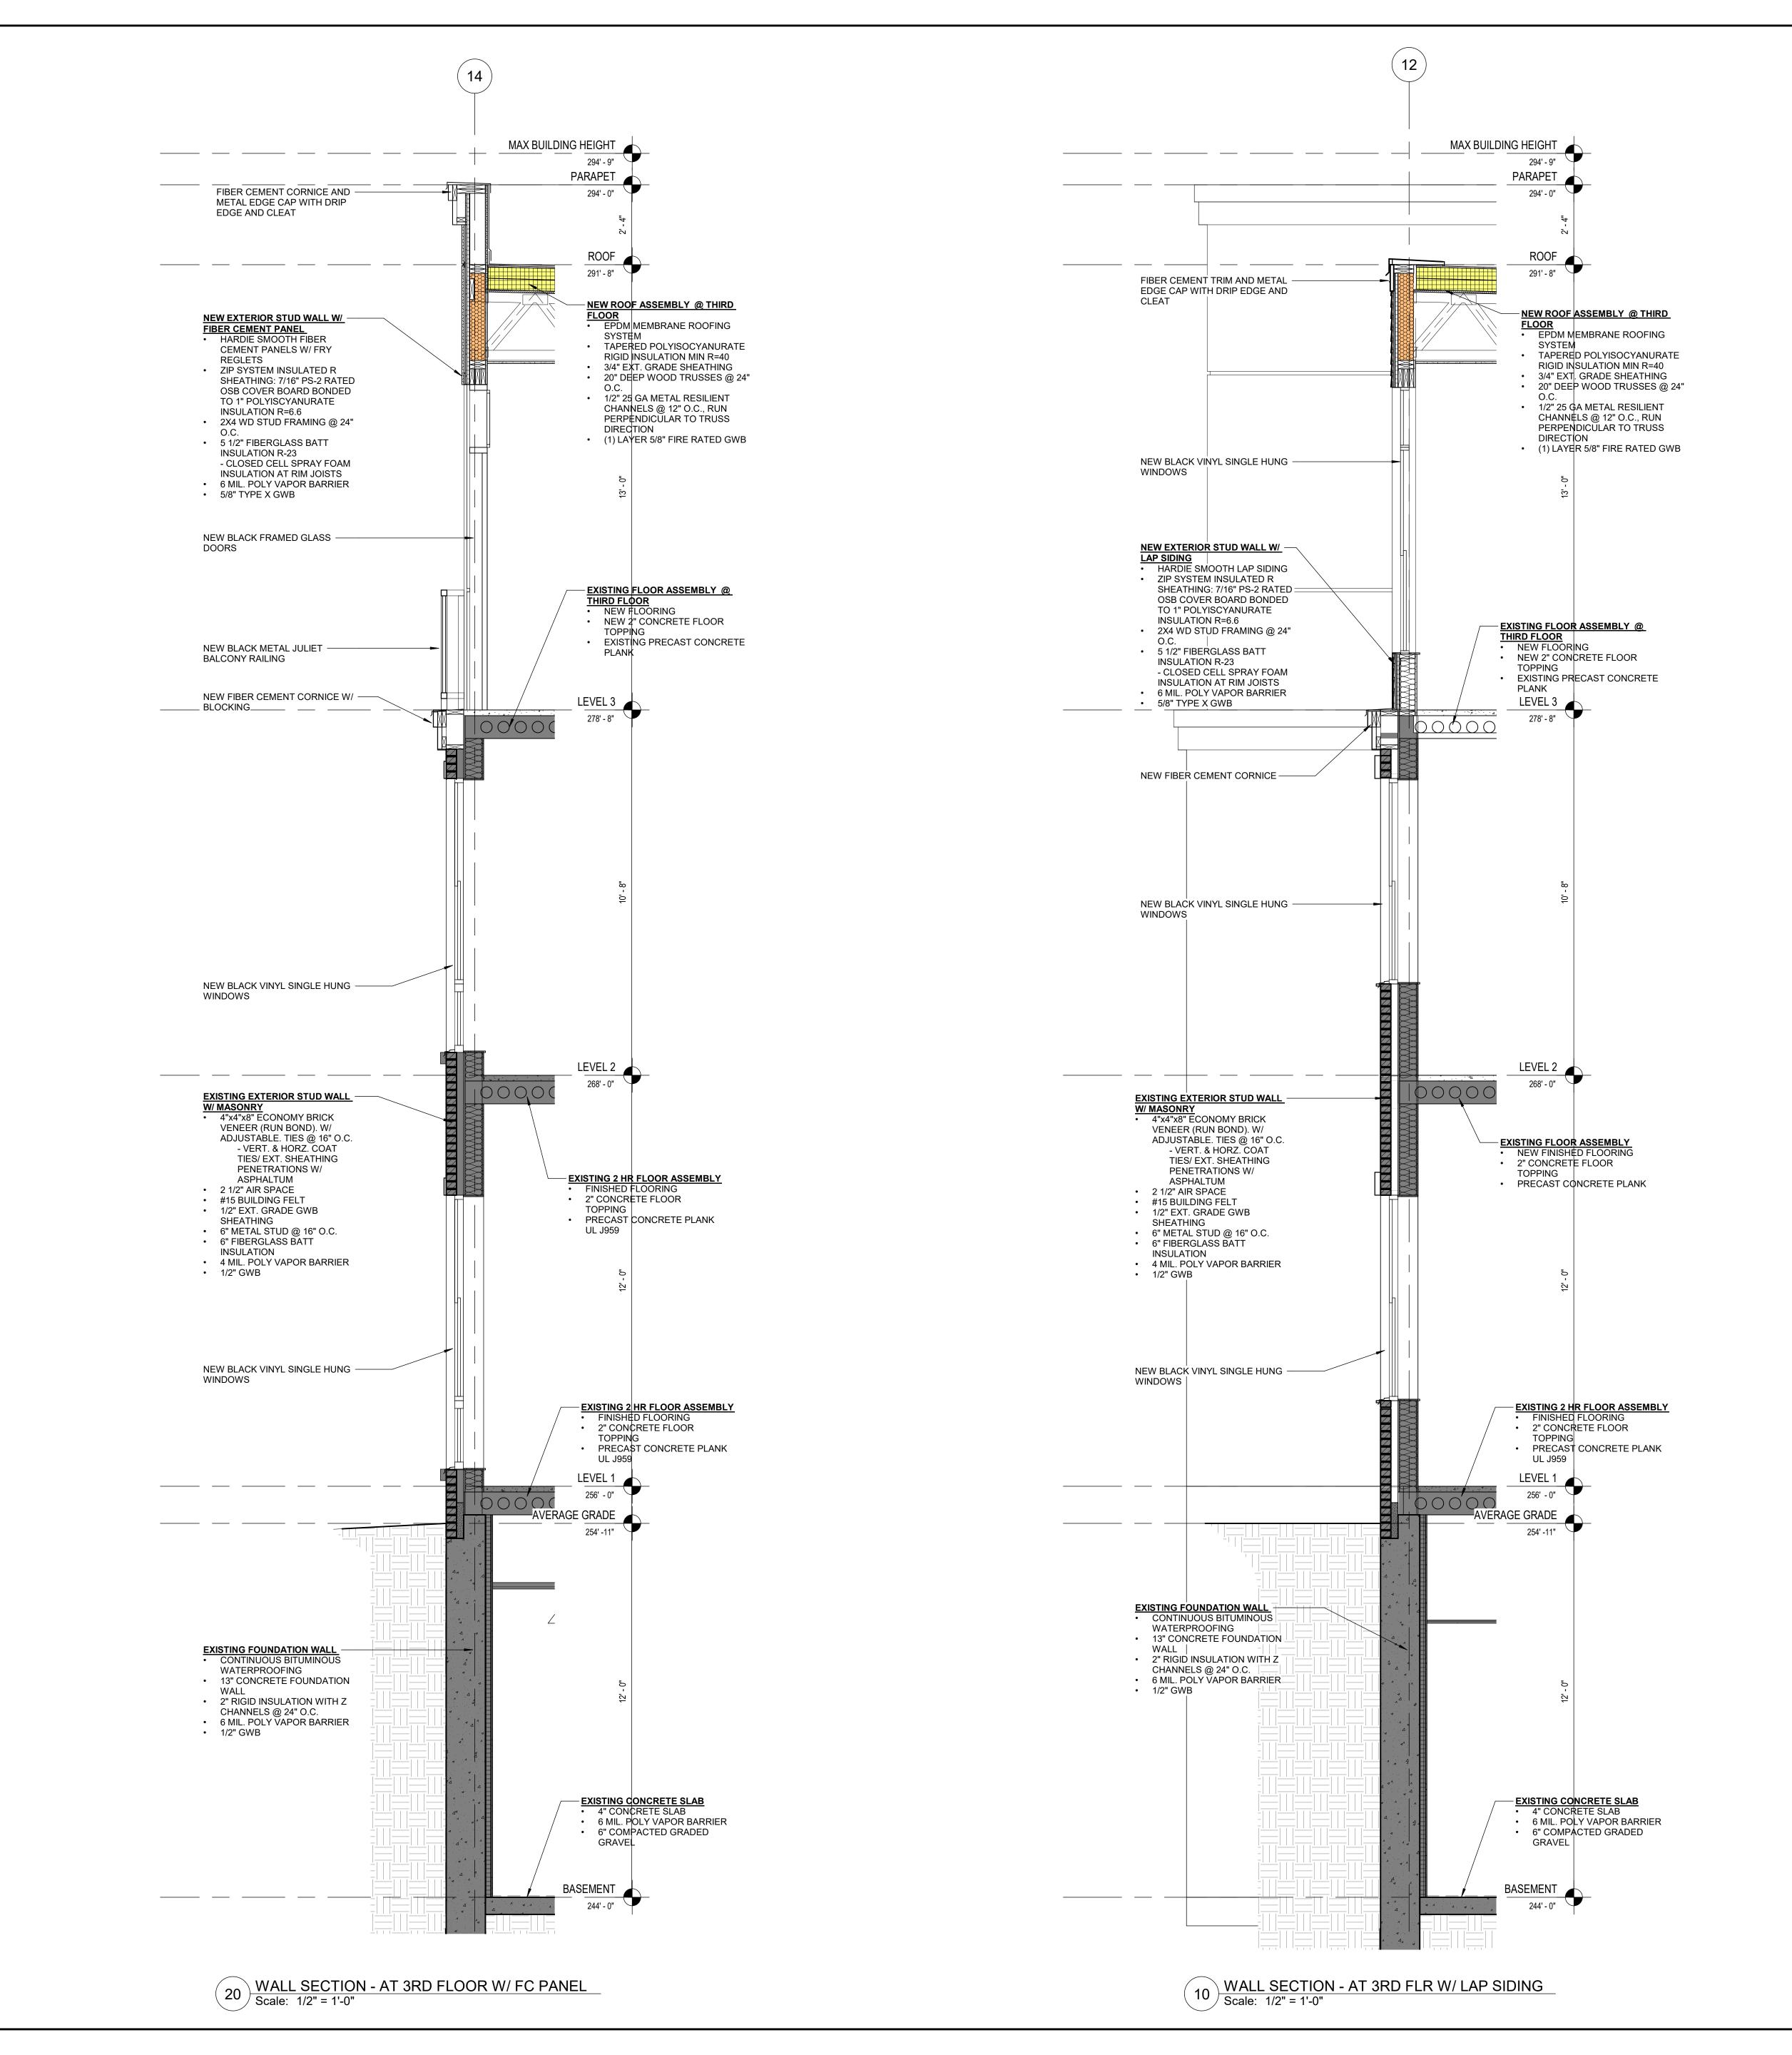


© The Architectural Team, Inc. 50 Commandant's Way at Admiral's Hill Chelsea MA 02150 O 617.889.4402 F 617.884.4329 architecturalteam.com

Consultant:	
Revision:	



Architect of Record:

Drawn:	JS
Checked:	AS
Scale:	1/2" = 1'-0"

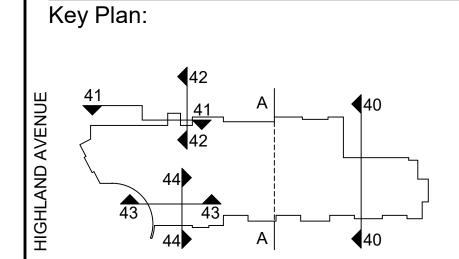

GOULD STREET

Project Name:
WINGATE AT NEEDHAM
RENOVATION /
EXPANSION

589 HIGHLAND AVENUE NEEDHAM, MA.

Sheet Name:

WALL SECTIONS

Project Number:

21056

Issue Date: FEBRUARY 3, 2023

Sheet Number:

A5.01



















# SIDING

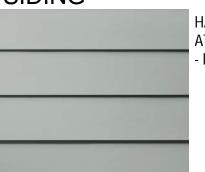


HARDIE PLANK LAP SIDING AT THIRD FLOOR ADDITION - LIGHT MIST



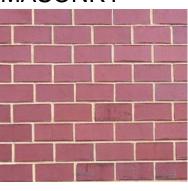

EXISTING RED BRICK TO REMAIN

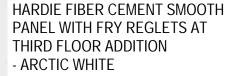




EXISTING YELLOW BRICK PAINTED - SW GRIZZLE GRAY





HARDIE FIBER CEMENT SMOOTH PANEL WITH FRY REGLETS ACCENT COLOR & ROOF CAP AT LIGHT MIST LAP SIDING - NIGHT GRAY

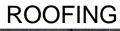



ARCHITECTURAL ASPHALT SHINGLES WHERE ROOFING SLOPES





1/2" REVEAL FRY REGLET AT FIBER CEMENT PANELS - MILLED FINISH





VINYL SINGLE HUNG WINDOWS MUNTINS AS SHOWN ON ELEVATIONS - BLACK

RAILINGS



PRE-FINISHED ALUMINUM
JULIET BALCONY RAILINGS
- BLACK







Gould Street Looking South



Side Entrance



Intersection of Gould Street and Highland Ave.



Rear Parking





# WINGATE AT NEEDHAM RENOVATION/EXPANSION

589 HIGHLAND AVENUE NEEDHAM, MASSACHUSETTS


# PLANNING BOARD SUBMISSION FOR SITE PLAN REVIEW

FEBRUARY 3, 2023

LIST	OF DRAWINGS:	SET Date
L1	SITE LANDSCAPE PLAN	2/3/23
L1.1	ILLUSTRATIVE SITE PLAN RENDERING	2/3/23
L2	ENTRY LANDSCAPE PLAN	2/3/23
L3	PARKING / PATIO LANDSCAPE PLAN	2/3/23
<b>D</b> 1	PLANTING DETAILS	2/3/23
D2	PLANTING NOTES	2/3/23




PREPARED BY:

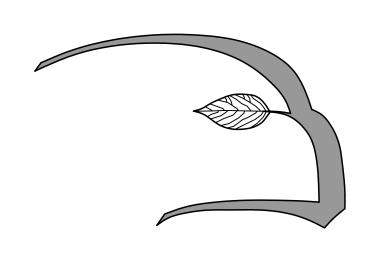



Hawk Design, Inc.
Landscape Architecture
Land Planning


Sagamore, MA 508-833-8800 info@hawkdesigninc.com

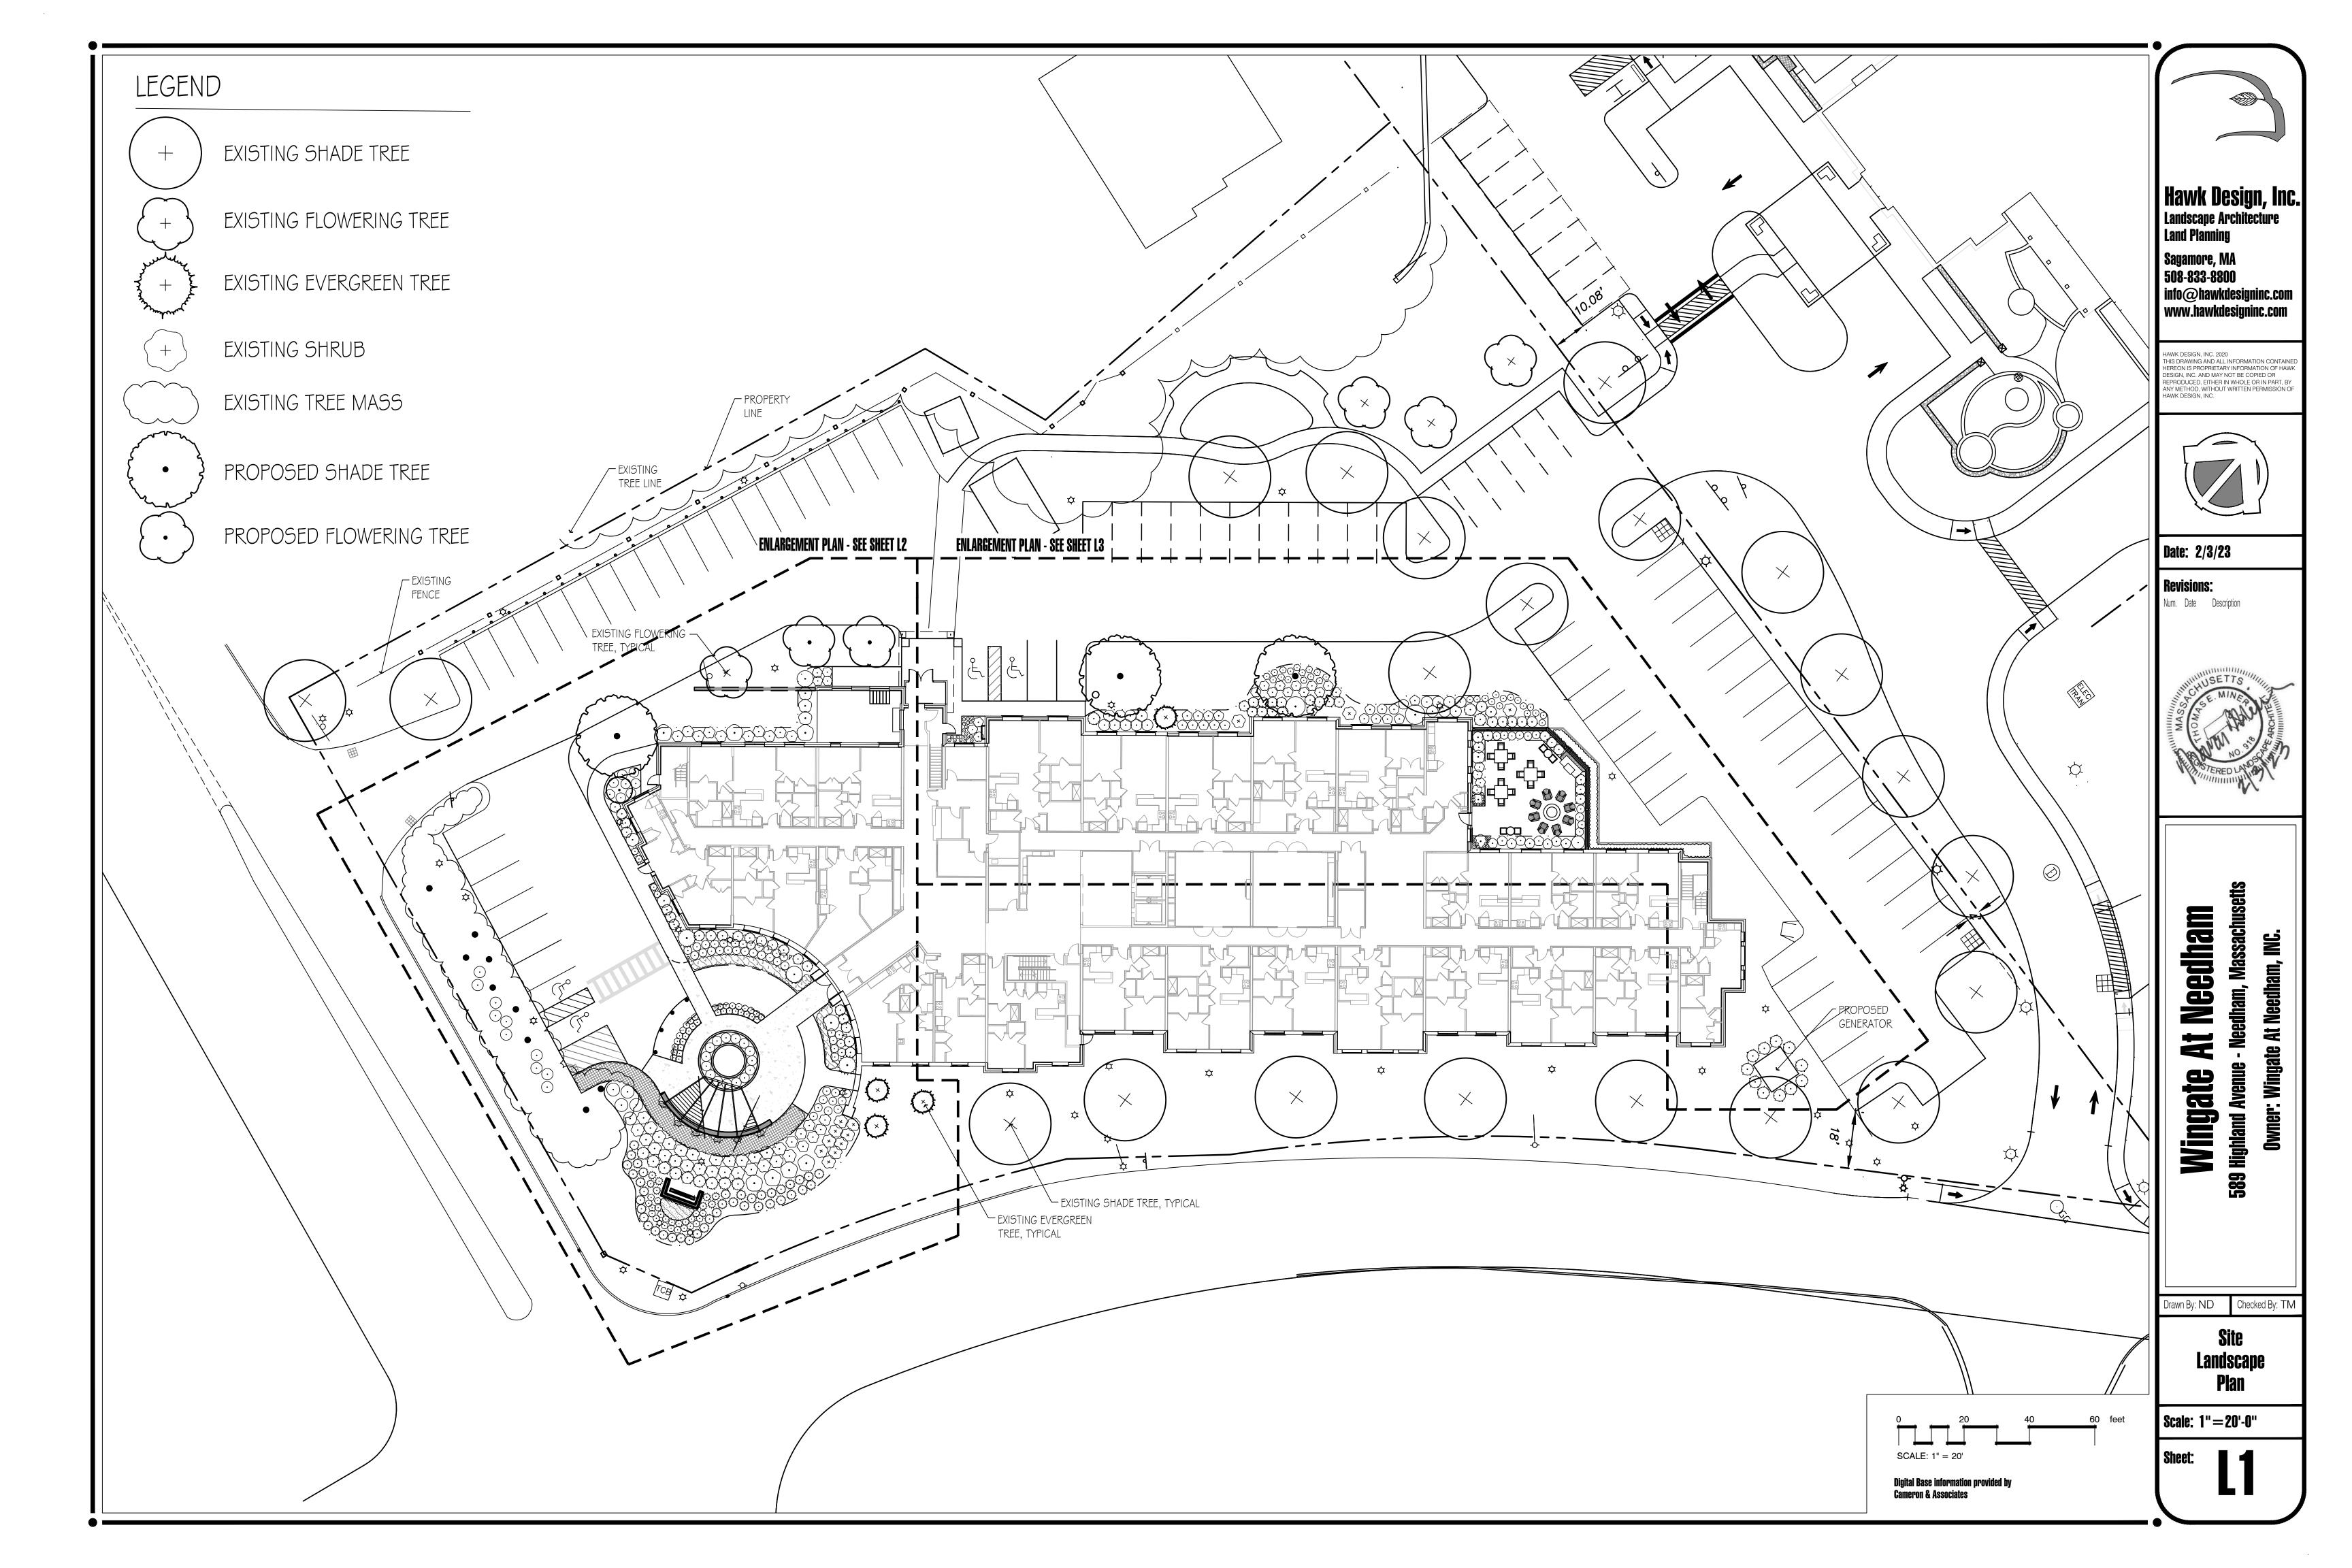



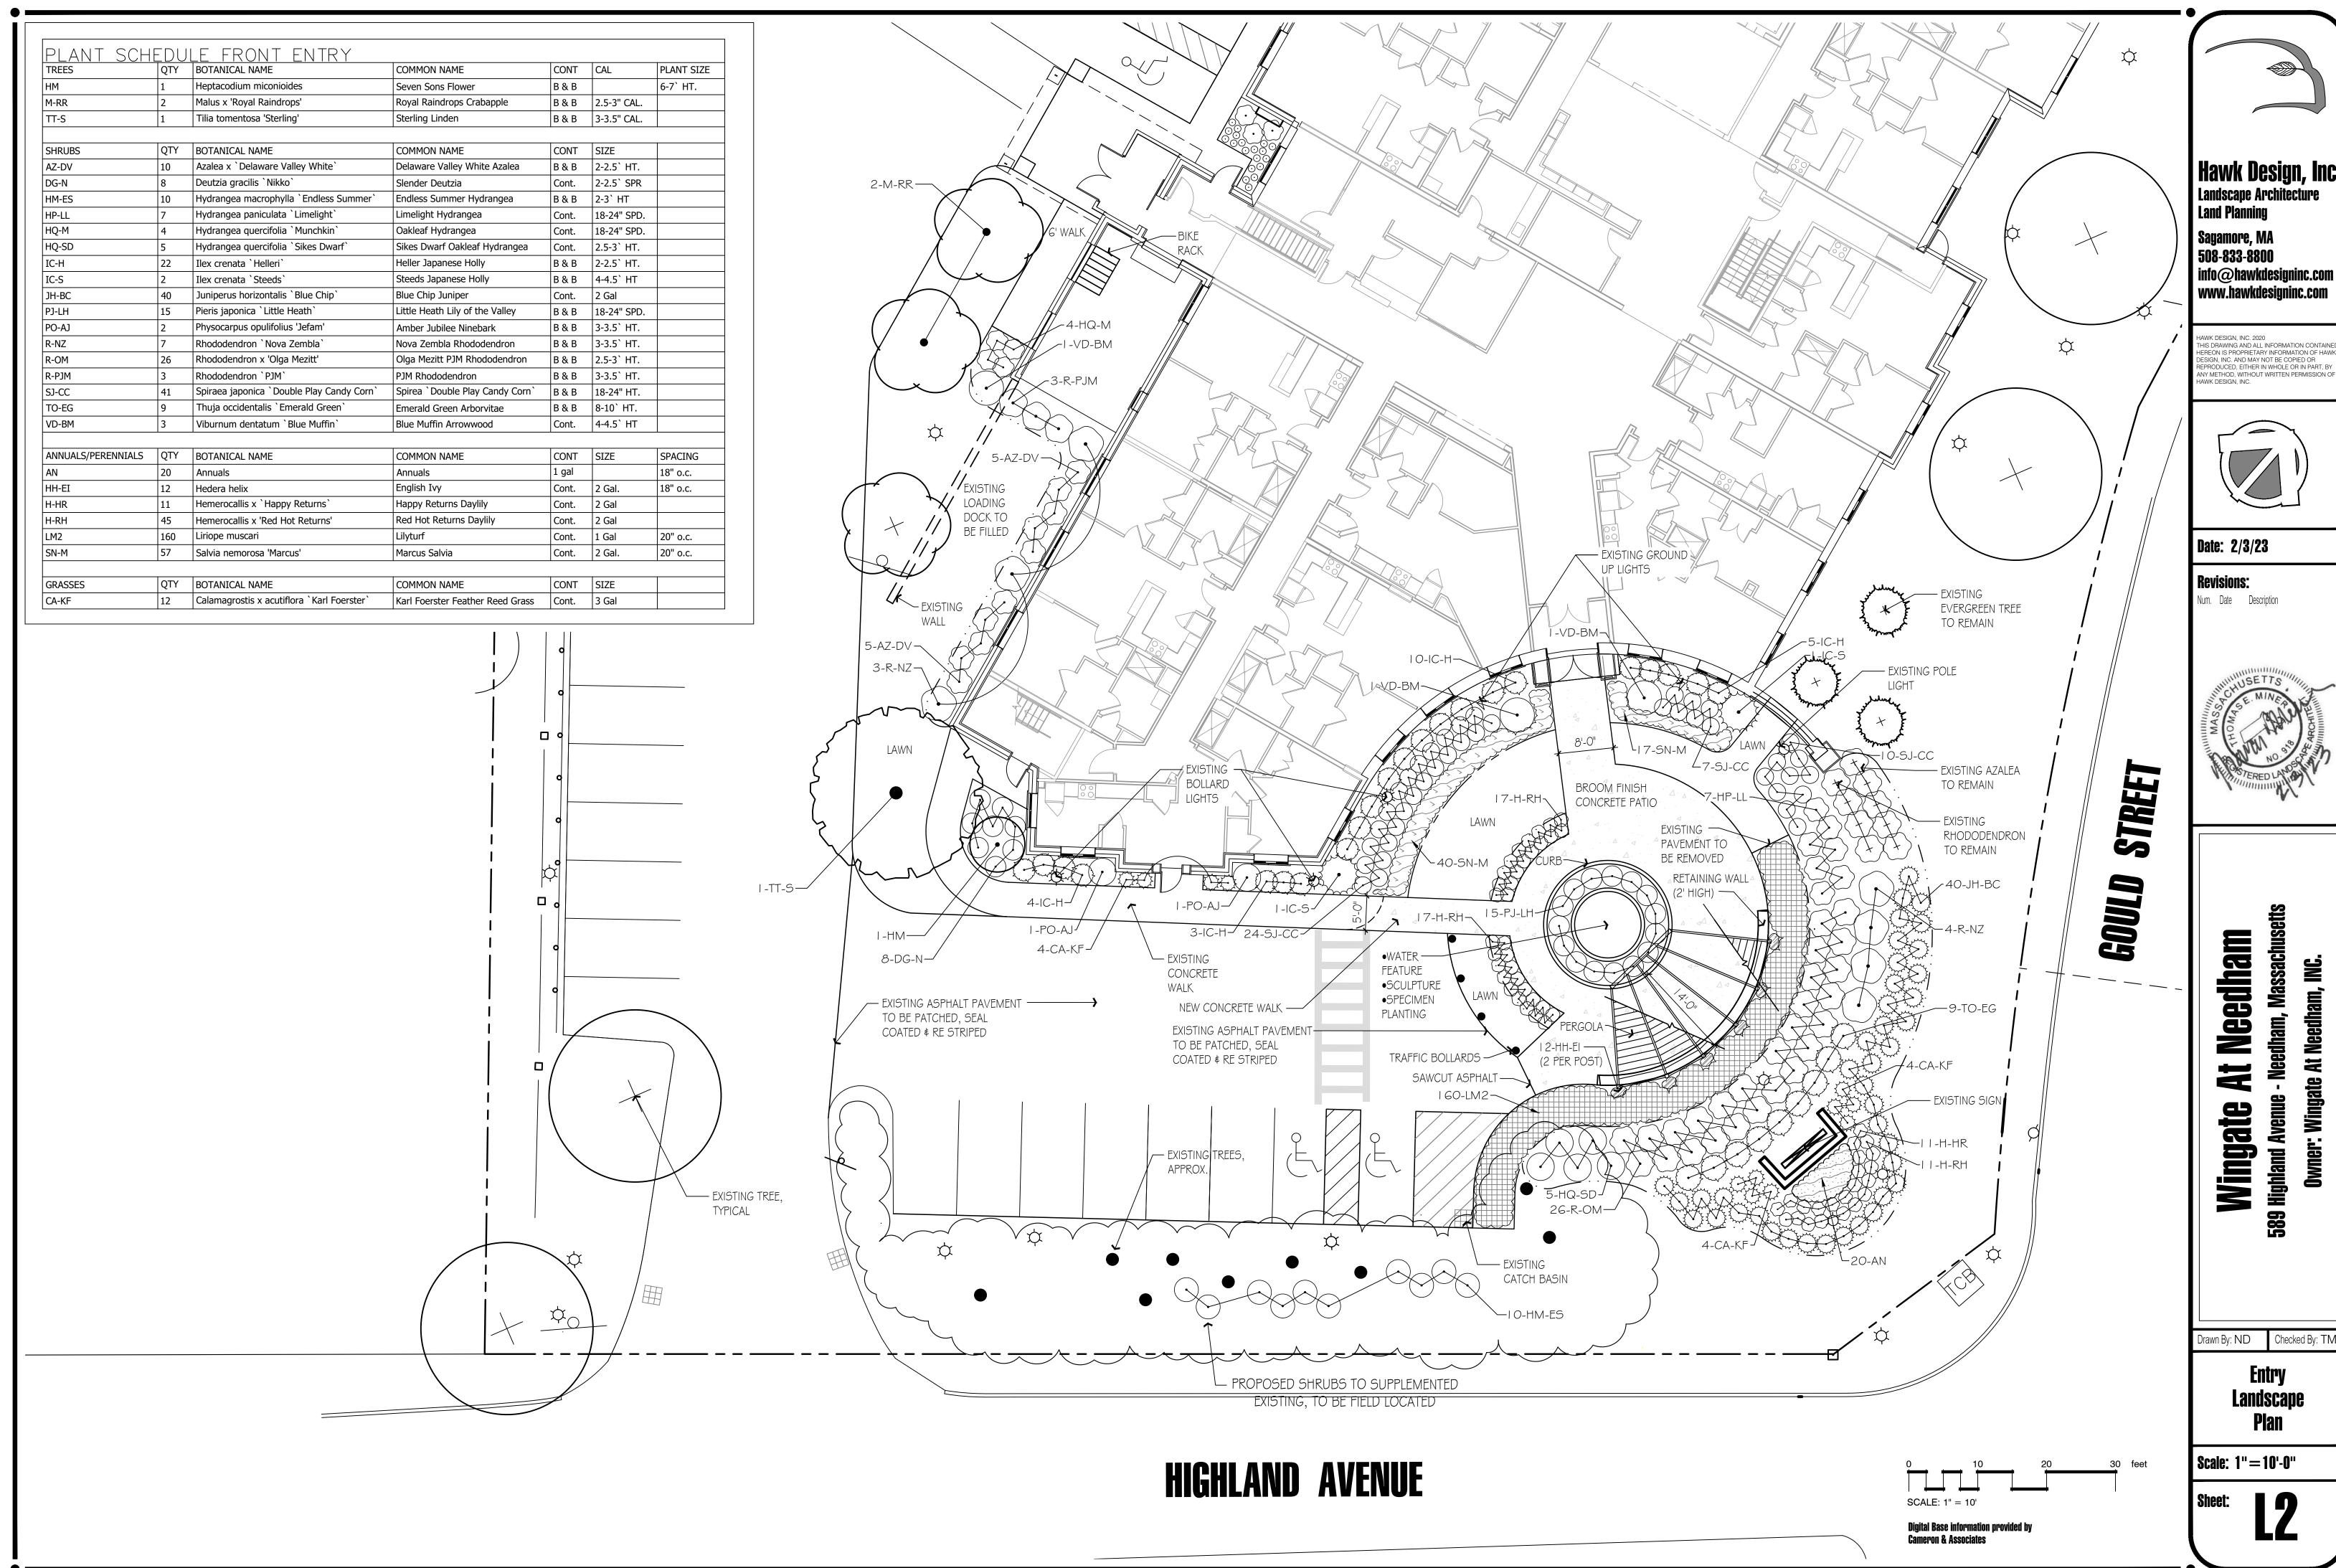


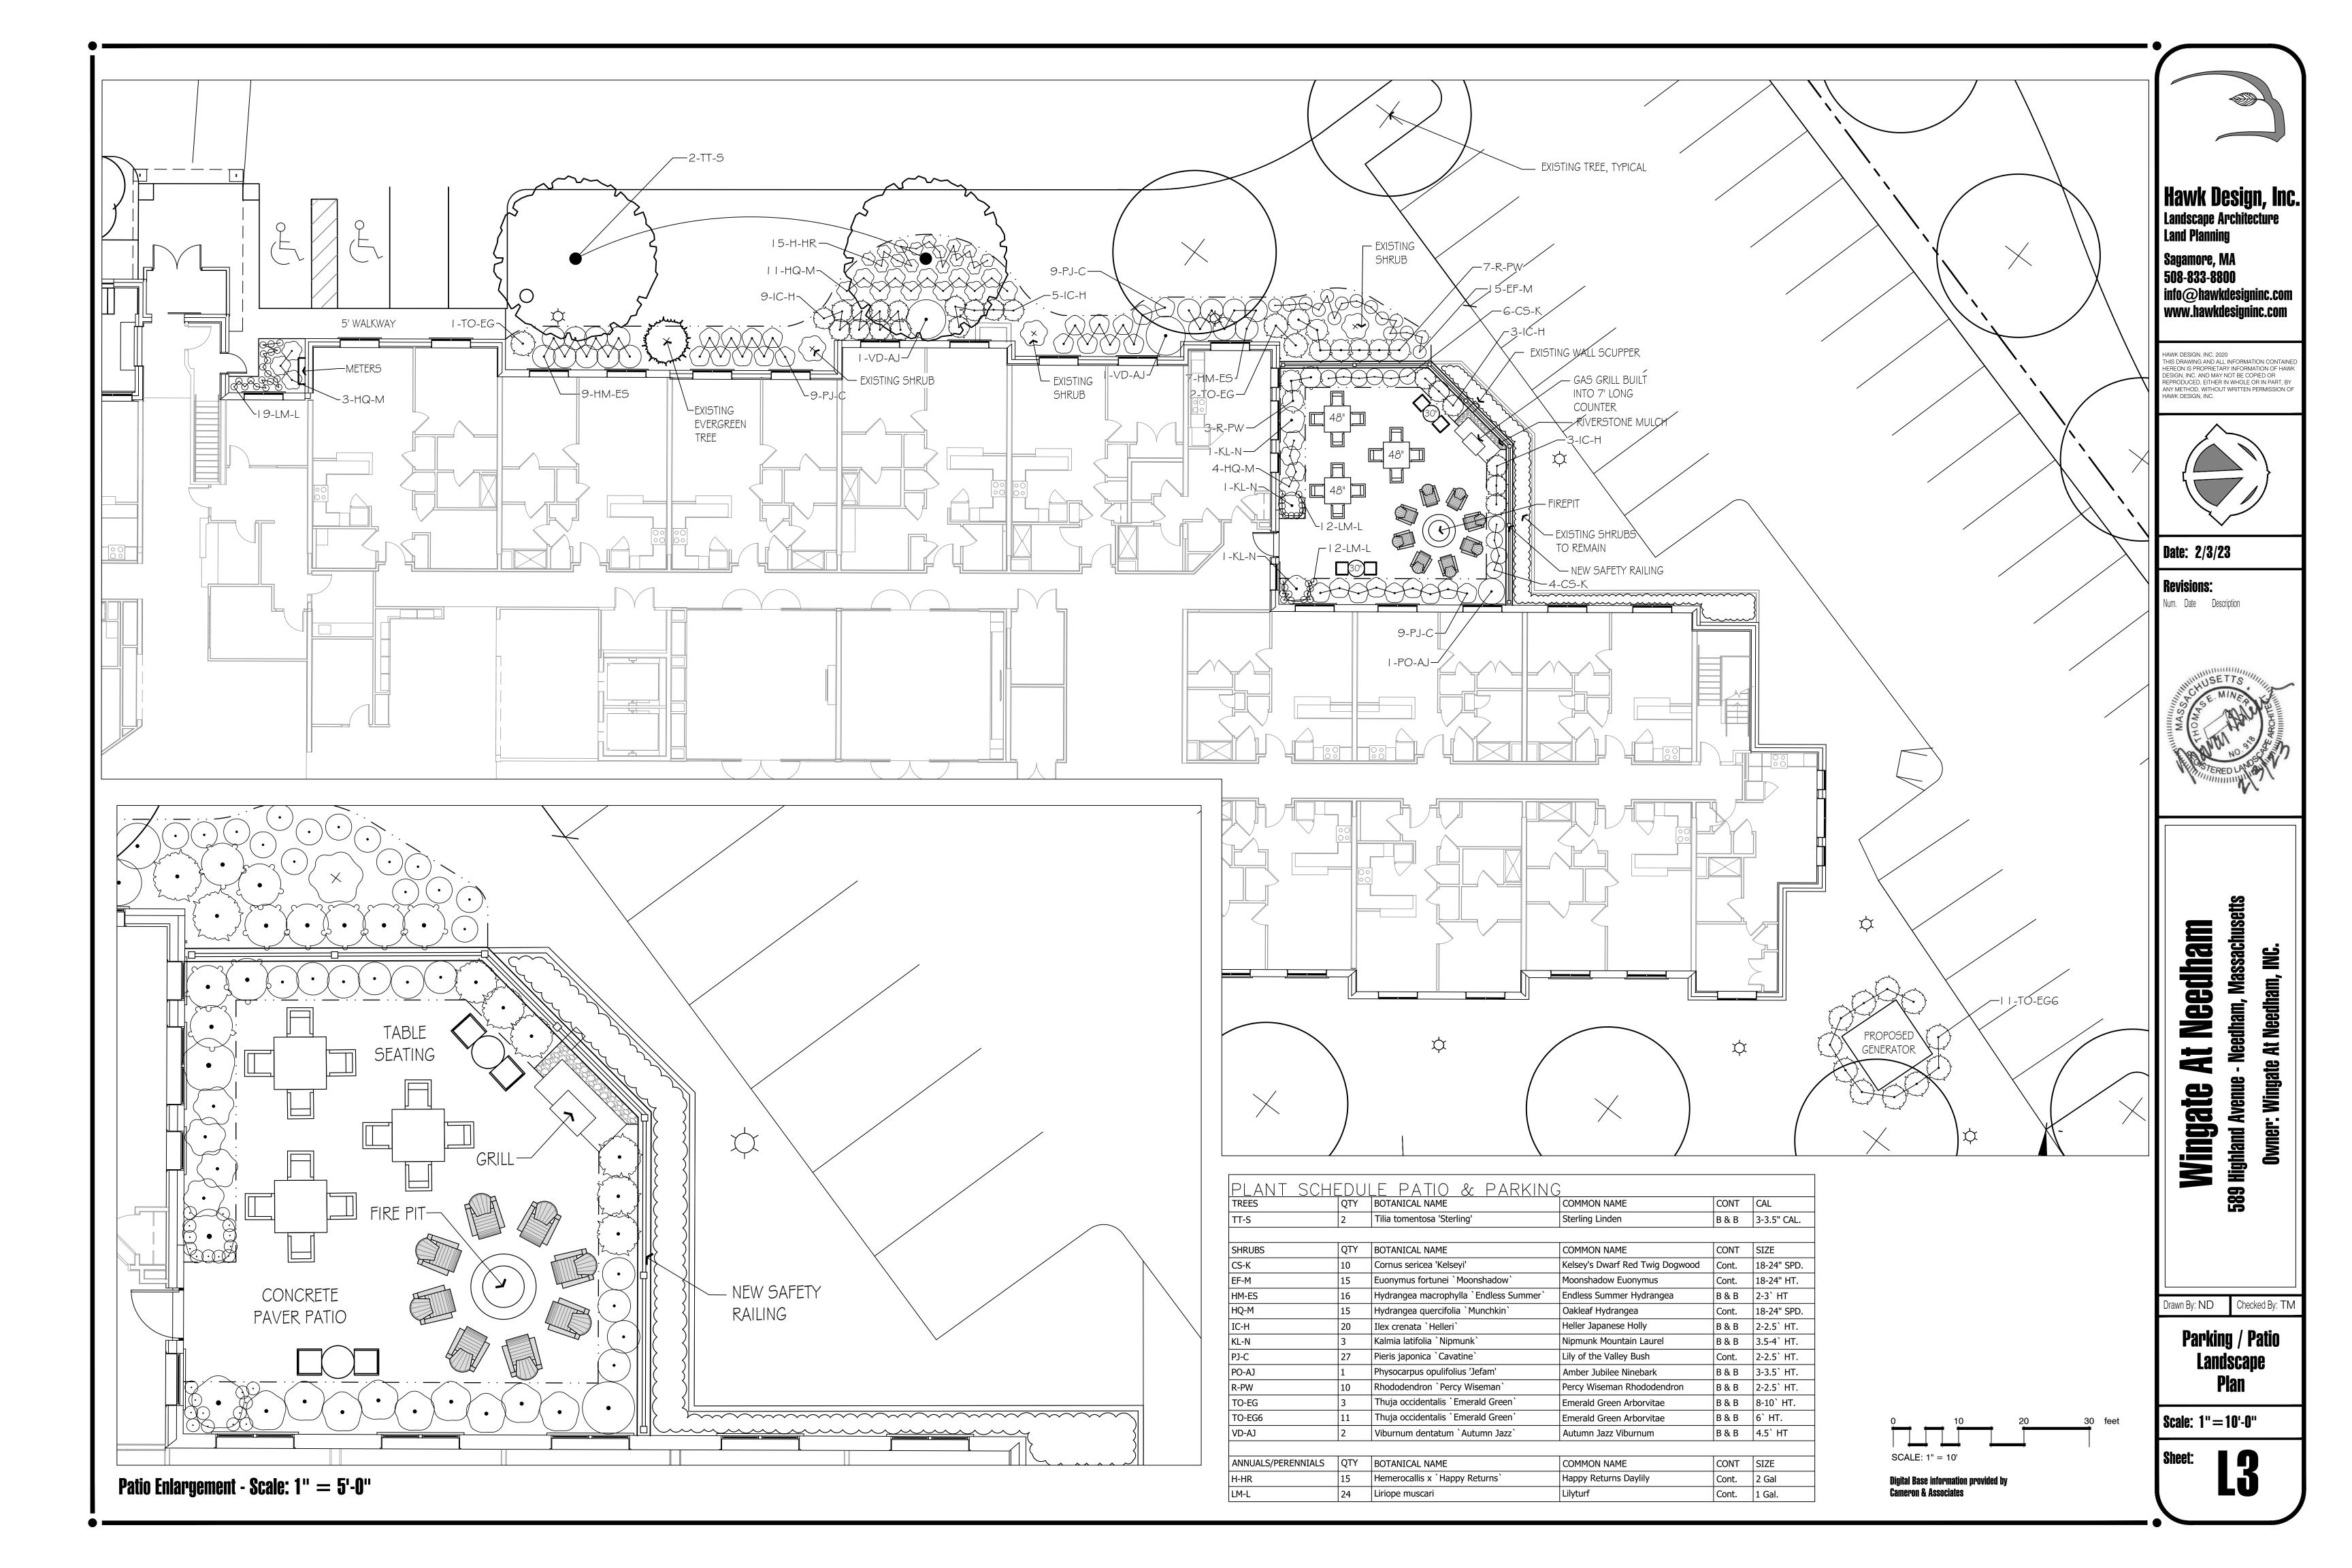

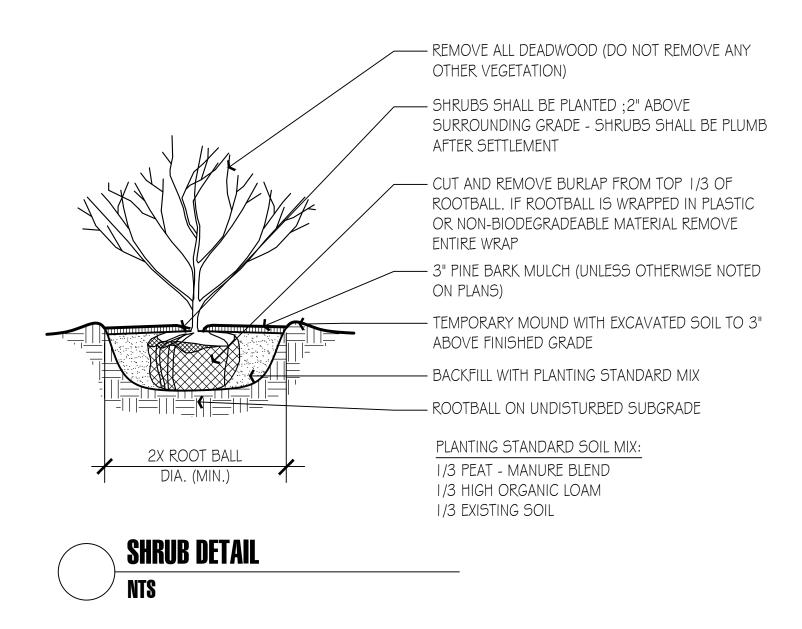

# SCHEDULE OF TOPSOILS & ADDITIVES

LOCATION	DEPTH	DESCRIPTION				
GENERAL PLANTING BEDS	6"	1/3 PEAT - MANURE BLEND 1/3 HIGH ORGANIC LOAM 1/3 EXISTING SOIL				
FLOWER BEDS	6"	SCREENED LOAM 1/3 PEAT - MANURE BLEND LIME - PELATIZED OR GROUND (50 LB. PER 100 SF.) GROUND BONE MEAL (50 LB. PER 100 SF.) 10-10-10 ORGANIC FERTILIZER (50 LB. PER 5000 SF.)				
LAWNS - SOD \$ SEED	6"	6" SCREENED LOAM				
PITS/TREE WELLS "STANDARD MIX" FOR BACKFILL	12"	I/3 PEAT - MANURE BLEND SOIL MIX 'A' - I/3 HIGH ORGANIC LOAM I/3 EXISTING SOIL				
PITS/TREE WELLS "LITE WEIGHT MIX"	12"	70% LIGHT WEIGHT SHALE SOIL MIX 'B' - 20% SAND I 0% COMPOST				
PITS/TREE WELLS "STRUCTURAL MIX"	12"	SOIL MIX 'C' - MIX COMPOSITION TO BE SUPPLIED BY LANDSCAPE ARCHITECT.				

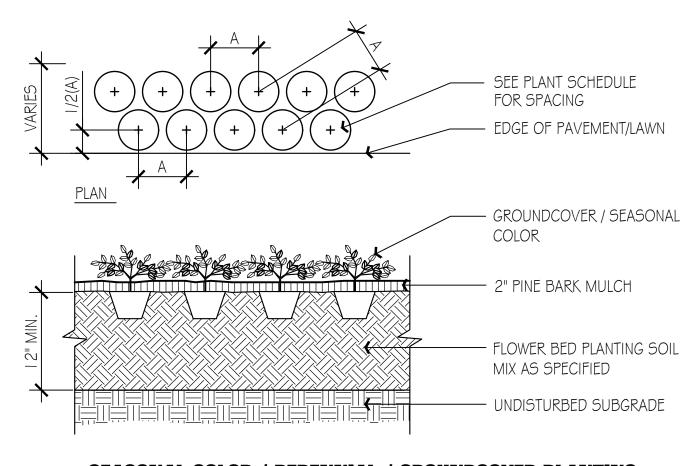



I) LAY SOD TO FORM A SOLID MASS WITH TIGHTLY FITTED JOINTS

2) BUTT ENDS AND SIDES OF SOD STRIPS

3) DO NOT OVERLAY EDGES


4) STAGGER STRIPS TO OFFSET JOINTS IN ADJACENT COURSES

5) REMOVE EXCESS SOD TO AVOID SMOTHERING OF ADJACENT GRASS


6) PROVIDE SOD PAD TOP FLUSH WITH ADJACENT STEEL EDGING AND PAVEMENT

SOD AS SPECIFIED - 6" LAWN SOIL MIX AS SPECIFIED — UNDISTURBED SUBGRADE



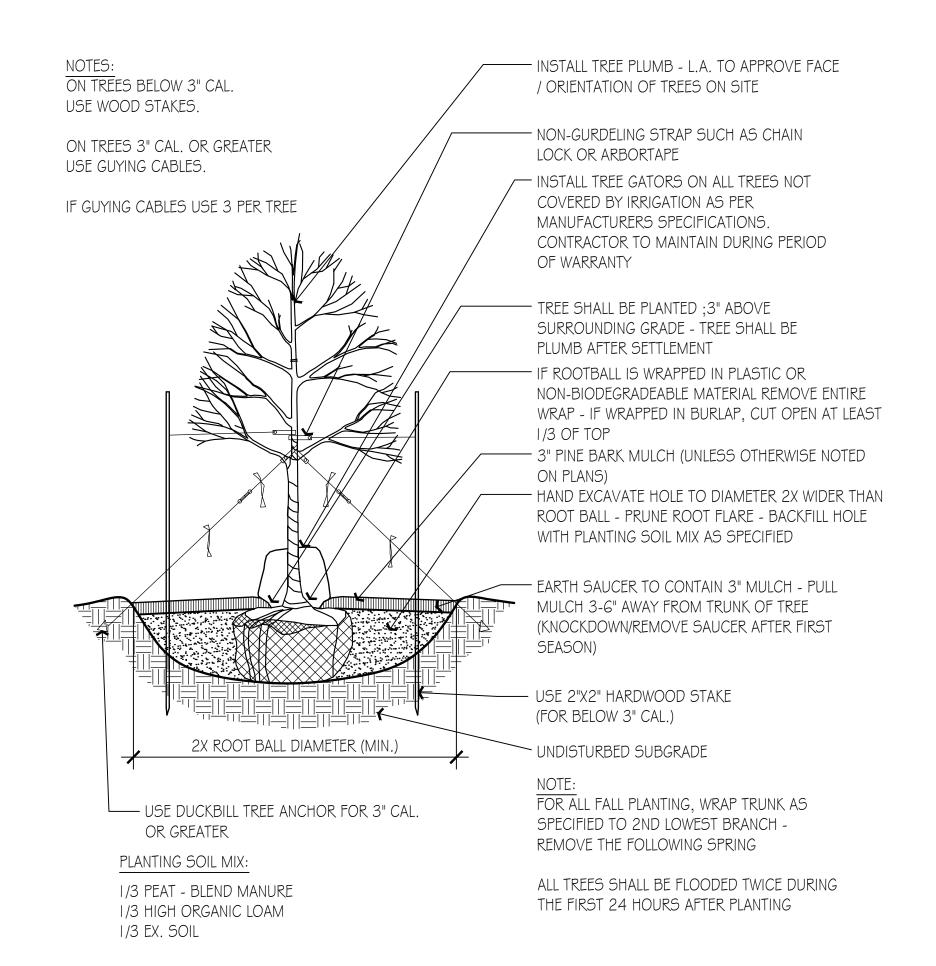



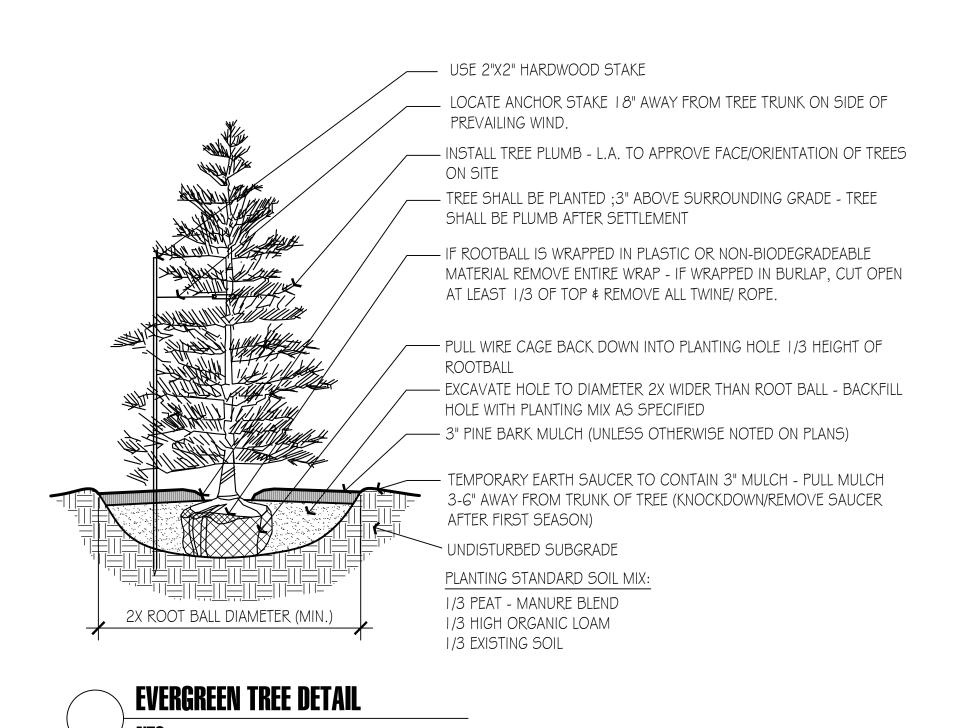



Hawk Design, Inc. **Landscape Architecture** Land Planning Sagamore, MA 508-833-8800

HAWK DESIGN, INC. 2013


HEREON IS PROPRIETARY INFORMATION OF HAWA DESIGN, INC. AND MAY NOT BE COPIED OR REPRODUCED, EITHER IN WHOLE OR IN PART, BY ANY METHOD, WITHOUT WRITTEN PERMISSION O

info@hawkdesigninc.com

Date: 2/3/23

**Revisions:** 

Num. Date Description

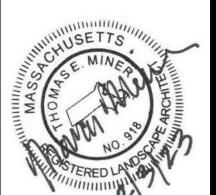

Needham A Wingate

Checked By:

**Details** 

Scale: As Noted

# General Landscape Notes:

- . I) CONTRACTOR REQUIREMENTS:
- A) ALL WORK SHALL COMPLY WITH APPLICABLE CODES AND REGULATIONS, FROM ALL FEDERAL, STATE AND LOCAL AUTHORITIES.
- B) THE CONTRACTOR SHALL ARRANGE FOR AND OBTAIN ALL PERMITS AND LICENSES REQUIRED FOR THE COMPLETE WORK SPECIFIED HEREIN AND SHOWN ON ALL THE DRAWINGS. THE CONTRACTOR SHALL PAY FOR ANY FEES NOT WAIVED.
- .2) UTILITIES
- A) LANDSCAPE CONTRACTOR IS REQUIRED TO CONTACT THE RELEVANT UTILITY COMPANIES PRIOR TO DOING ANY EXCAVATION ON THE SITE. IF ANY WORK IS TO BE DONE AROUND UNDERGROUND UTILITIES, THE APPROPRIATE AUTHORITY OF THAT UTILITY MUST BE NOTIFIED OF THE IMPENDING WORK.
- B) UTILITIES SHALL BE LOCATED AND MARKED PRIOR TO ANY INSTALLATION. ADJUSTMENTS MAY BE NECESSARY IN THE FIELD TO ACCOMMODATE UTILITY LOCATIONS. REPORT ANY CONFLICTS TO THE LANDSCAPE ARCHITECT PRIOR TO INSTALLATION.
- C) THE LANDSCAPE CONTRACTOR SHALL BE RESPONSIBLE FOR ANY DAMAGES DONE TO EXISTING UTILITIES. THE CONTRACTOR SHALL BE RESPONSIBLE FOR THE COST OF SATISFACTORY REPAIR OF ALL DAMAGE IN KIND RESULTING FROM THEIR FAILURE TO COMPLY.
- I.3) <u>PROTECTION OF EXISTING WORK:</u> IT SHALL BE THE CONTRACTOR'S RESPONSIBILITY TO PERFORM ALL WORK IN A MANNER THAT PROTECTS WORK COMPLETED BY OTHERS, SUCH AS CURBS, UTILITIES, STORM DRAINAGE, FENCES, DRIVEWAY APRONS, DRIVES, VEGETATION, ETC. THE CONTRACTOR SHALL BE RESPONSIBLE FOR THE COST OF SATISFACTORY REPAIR OF ALL DAMAGE IN KIND RESULTING FROM THEIR FAILURE TO COMPLY.
- I.4) QUANTITIES: A COMPLETE LIST OF PLANTS INCLUDING A SCHEDULE OF QUANTITIES, SIZES, TYPES, AND NAMES IS INCLUDED IN THIS SET OF DRAWINGS. IN THE EVENT OF DISCREPANCIES BETWEEN QUANTITIES OF PLANT IN THE PLANT LIST AND THE QUANTITIES SHOWN ON THE DRAWINGS, THE PLAN SHALL GOVERN. THE LANDSCAPE CONTRACTOR SHALL NOTIFY THE LANDSCAPE ARCHITECT OF UNLABELED PLANTS IN PLAN FOR CLARIFICATION. THE LANDSCAPE ARCHITECT SHALL BE ALERTED BY THE CONTRACTOR OF ANY DISCREPANCIES PRIOR TO FINAL BID NEGOTIATION.
- I.5) <u>APPLICABLE PLANT MATERIALS STANDARDS:</u> ALL PLANT MATERIALS ARE TO COMPLY WITH THE LATEST EDITION OF THE AMERICAN STANDARD FOR NURSERY STOCK AS PUBLISHED BY THE AMERICAN ASSOCIATION OF NURSERYMEN. PLANTING METHODS WILL BE IN ACCORDANCE WITH SITE-SPECIFIC REQUIREMENTS.
- I.6) PLANT HARDINESS: ALL TREES AND SHRUBS SHALL BE NURSERY GROWN WITHIN A USDA PLANT HARDINESS ZONE, WHICH IS THE SAME AS, OR COLDER THAN, THE ZONE IN WHICH THE PROJECT IS LOCATED.
- 1.7) <u>PLANTING SEASONS:</u> PLANTING SHALL ONLY OCCUR DURING SPECIFIED SEASONS. SPRING SEASON SHALL BE FROM MARCH 1 TO JUNE 15. FALL PLANTING SEASON SHALL BE FROM SEPTEMBER 15 THROUGH NOVEMBER 15. NO PLANTING SHALL OCCUR WHEN THE GROUND IS FROZEN.
- I.8) PLANT SUBSTITUTIONS: NO SUBSTITUTIONS OF PRODUCTS, PLANT TYPES OR SIZES SHALL BE MADE WITHOUT THE WRITTEN APPROVAL OF THE LANDSCAPE ARCHITECT. REQUESTS FOR SUBSTITUTION SHALL BE IN WRITING, AND SHALL STATE THE REASON FOR THE SUBSTITUTION REQUEST, THE SUGGESTED ALTERNATIVE AND THE CHANGES IN COST. REQUESTS FOR SUBSTITUTION IN PLANT MATERIALS SHALL STATE THE NAMES OF NURSERIES THAT HAVE BEEN UNABLE TO SUPPLY THE ORIGINALLY SPECIFIED MATERIAL.
- I.9) THE LANDSCAPE ARCHITECT SHALL RESERVE THE RIGHT TO INSPECT ALL PLANT MATERIALS AT THE NURSERY, UPON SITE DELIVERY AND DURING INSTALLATION TO INSURE SPECIFICATIONS AND PROCEDURES ARE ADHERED TO.
- I.IO) MINIMUM SIZES: ALL PLANTS 3' OR GREATER IN HEIGHT OR SPREAD SHALL BE BALLED AND BURLAPPED. SIZES SPECIFIED IN THE PLANT LIST ARE MINIMUMS ON WHICH THE PLANTS ARE TO BE
- I.II) DEAD PLANTS: DEAD PLANTS ARE TO BE REMOVED FROM THE SITE IMMEDIATELY, AND REPLACED WITH THE SAME PLANT \$ SIZE REGARDLESS OF SEASON, WEEKLY FROM THE JOB BY THE CONTRACTOR. THE CONTRACTOR SHALL MAINTAIN AN UPDATED COMPREHENSIVE LIST OF ALL DEAD MATERIALS REMOVED AND PRESENT A COPY OF THE LIST TO THE OWNER AND LANDSCAPE ARCHITECT AT THE END OF EVERY MONTH DURING THE CONTRACT PERIOD.
- I.I2) PLANT MATERIAL REMOVAL: NO EXISTING TREES SHALL BE REMOVED WITHOUT THE WRITTEN AUTHORIZATION FROM THE LANDSCAPE ARCHITECT EXCEPT WHERE NOTED ON THE PLANS. CONTRACTORS WHO REMOVE EXISTING TREES WITHOUT WRITTEN APPROVAL WILL BE REQUIRED TO MAKE REMEDIES DETERMINED BY THE GOVERNING URBAN FORESTER OR EQUIVALENT AUTHORITY. NO GRUBBING SHALL OCCUR WITHIN EXISTING TREE AREAS UNLESS SPECIFICALLY NOTED ON THE PLANS.
- I.I3) ALL DISTURBED AREAS NOT TO RECEIVE PLANT MATERIALS ARE TO BE LOAMED AND SEEDED AND BLENDED INTO EXISTING GRADE AND CONDITIONS. SEE SECTION 4.0.
- I.14) LEDGE BOULDERS: IF DURING SITE EXCAVATION, LEDGE BOULDERS ARE AVAILABLE, THESE ARE TO BE STOCKPILED FOR USE IN EARTH BERMS IF APPLICABLE, WITH HAWK DESIGN, INC. PRIOR TO INSTALLATION. THIS ITEM WILL ONLY APPLY IF SO SPECIFIED ON DRAWINGS. BOULDERS SIZES TO BE STOCKPILED WILL RANGE FROM TWO TO FIVE FEET IN DIAMETER. SEE APPROPRIATE DETAIL FOR INSTALLATION COORDINATION.
- I.15) <u>SLEEVES:</u> LANDSCAPE OR SITE CONTRACTOR SHALL PLACE INDIVIDUAL SLEEVES FOR LIGHTING AND IRRIGATION UNDER ANY PROPOSED WALKWAY OR VEHICULAR ROADWAY PRIOR TO INSTALLATION. COORDINATE SLEEVE LOCATIONS WITH IRRIGATION AND LIGHTING CONTRACTORS PRIOR TO INSTALLATION.
- I.16) DO NOT CLOSE OR OBSTRUCT ANY STREET, SIDEWALK, ALLEY OR PASSAGEWAY WITHOUT PRIOR NOTIFICATION AND PERMISSION. CONDUCT OPERATIONS AS TO INTERFERE AS LITTLE AS POSSIBLE WITH THE USE ORDINARILY MADE OF ROADS, DRIVEWAYS, ALLEYS, SIDEWALKS OR OTHER FACILITIES NEAR ENOUGH TO THE WORK TO BE EFFECTED THEREBY.

# **Planting Materials:**

- 2.1 PLANTING MATERIAL ITEMS IN SECTION 2.0 ARE TO BE INCORPORATED DURING PLANT INSTALLATION UNLESS OTHERWISE DEEMED UNNECESSARY IN ACCORDANCE WITH SOIL TEST RECOMMENDATIONS. SEE SECTION
- MULCH MULCH WILL BE DOUBLE-SHREDDED PINE BARK MULCH.

   TREES AND SHRUBS SHALL RECEIVE AN EVEN 3" MULCH LAYER.

   GROUNDCOVERS, PERENNIALS AND ANNUALS SHALL RECEIVE AN EVEN 2" MULCH LAYER.
- MANURE- TO BE WELL ROTTED, ODORLESS, UNLEACHED COW MANURE, CONTAINING NOT MORE THAN 15% BEDDED MATERIALS SUCH AS STRAW, WOOD CHIPS OR SHAVINGS, AGED NOT LESS THAN TWO YEARS OLD.
- HERBICIDE- A PRE-EMERGENCE WEED KILLER IS TO BE USED ON ALL LAWN AND PLANTING AREAS PRIOR TO INSTALLATION AS PER MANUFACTURER'S SPECFICATIONS. \*HERBICIDES ARE NOT TO BE APPLIED IN RESTRICTED CONSERVATION AREAS.
- FERTILIZER- ALL TREES AND SHRUBS TO HAVE SLOW RELEASE PACKET OR PELLET PLACED INTO THE PLANT PIT WITH A MINIMUM ANALYSIS OF 10-10. ALL GROUNDCOVERS, PERENNIALS AND ANNUALS ARE TO RECIEVE A BROADCAST APPLICATION OF A 14-14-14 FERTILZER AT 3 LB PR 100 SQ. FT. APPLY AS PER MANUFACTURER'S INSTRUCTIONS. \*FERTILIZERS ARE NOT TO BE APPLIED IN RESTRICTED CONSERVATION AREAS.
- TOPSOIL- ACCEPTABLE TOPSOIL SHALL BE FERTILE, FRIABLE NATURAL LOAM, UNIFORM IN COMPOSITION, FREE OF STONES, LIMBS, PLANTS AND THIER ROOTS, DEBRIS AND OTHER EXTRANEOUS MATTER OVER ONE INCH IN DIAMETER. THE SOIL SHALL BE CAPABLE OF SUSTAINED PLANT GROWTH AND HAVE A 5% MINIMUM ORGANIC CONTENT. IN SITUATIONS WHICH REQUIRE A CUSTOM TOPSOIL OR STRUCTURAL SOIL, THE SOIL MIXTURE SPECIFICATION WILL BE PROVIDED BY THE LANDSCAPE ARCHITECT.
- SOIL AMENDMENTS: APPLY AS NECESSARY ACCORDING TO SOIL TEST RESULTS, AS PER MANUFACTURES SPECIFICATIONS.
- ANTI-DESICCANT- "WILT PRUF" NCF OR EQUAL APPLY AS PER MANUFACTURERS' SPECIFICATIONS.

# **Plant Installation:**

- 3.1) SOIL TESTING: LANDSCAPE CONTRACTOR SHALL PROVIDE A CERTIFIED SOIL ANALYSIS PRIOR TO ANY PLANT INSTALLATION TO DETERMINE ANY NECESSARY AMENDMENTS TO THE EXISTING SOIL CONDITIONS FOR SEEDING AND PLANTING. THE ANALYSIS WILL ALSO BE REQUIRED FOR ESTABLISHING THE FERTILIZER PROGRAM REQUIRED. COORDINATE RESULTS AND PROVIDE WRITTEN RECOMMENDATIONS TO HAWK DESIGN, INC. 15 DAYS PRIOR TO INSTALLATION.
- 3.2) ALL PLANTS SHALL BE TRANSPORTED TO THE SITE IN COVERED TRUCKS, TARPAULIN COVERS SHALL BE UTILIZED TO PREVENT WIND DAMAGE OF LOAD.
- 3.3) DELIVER PLANT MATERIALS IMMEDIATELY PRIOR TO PLACEMENT. KEEP PLANT MATERIALS MOIST. DO NOT STORE PLANT MATERIAL ON PAVED AREAS. ROOTS OR BALLS SHALL BE PROTECTED FROM THE SUN OR DRYING WINDS. AS REQUIRED BY TEMPERATURE OR WIND CONDITIONS, APPLY ANTI-DESICCANT EMULSION TO PREVENT DRYING OUT OF PLANT MATERIALS.
- 3.4) CONDITIONS FOR PLANT REJECTION:
- A) REJECT PLANTS WHEN BALL OF EARTH SURROUNDING ROOTS HAS BEEN CRACKED OR BROKEN PREPARATORY TO OR DURING THE PROCESS OF PLANTING.
- B) WHEN BURLAP, STAVES AND ROPES REQUIRED IN CONNECTION WITH TRANSPLANTING HAVE BEEN DISPLACED PRIOR TO ACCEPTANCE.
- C) WIND DAMAGED PLANT MATERIAL FROM POOR TARPAULIN COVER PROCEDURES ARE SUBJECT TO REJECTION.
- 3.5) ALL PLANT MATERIAL, WHICH CANNOT BE PLANTED IMMEDIATELY ON DELIVERY, SHALL BE SET ON THE GROUND IN A SHADED LOCATION AND SHALL BE TEMPORARILY PROTECTED WITH SOIL OR OTHER ACCEPTABLE MATERIAL. TEMPORARY WATERING OR IRRIGATION SHALL BE INCORPORATED AND REGULARLY CONDUCTED ON PLANTINGS IN HOLD AREAS.
- 3.6) IN CASE OF CONFLICTS DURING CONSTRUCTION WITH UTILITIES, ROCK MATERIALS, TREE ROOTS OR OTHER OBSTRUCTIONS FOR THE EXCAVATION OF SHRUB BEDS AND TREE PITS. CONTACT LANDSCAPE ARCHITECT FOR APPROVED ALTERNATE LOCATIONS.
- 3.7) <u>SOIL PERMABILITY</u>: TEST DRAINAGE OF PLANTING BEDS AND PITS BY FILLING WITH WATER TWICE IN SUCCESSION. CONDITIONS PERMITTING THE RETENTION OF WATER FOR MORE THAN 24 HOURS SHALL BE BROUGHT TO THE ATTENTION OF THE LANDSCAPE ARCHITECT.

# 3.8) SOIL EXCAVATIONS:

- A) EXCAVATE TREE PITS AND SHRUB BEDS TO DEPTHS REQUIRED BY PLANTING DETAILS. ALL PITS SHALL BE CIRCULAR IN OUTLINE, EXCEPT FOR WHOLE BEDS. SEE APPROPRIATE PLANTING DETAILS.
- B) SOIL EXCAVATIONS FOR BALLED & BURLAP AND CONTAINER PLANTINGS MUST BE NO LESS THAN 2X ROOT BALL DIAMETER, SEE PLANTING DETAILS. IF QUESTIONABLE SUBSURFACE SOIL CONDITIONS EXIST SUCH AS POOR DRAINAGE CONDITIONS, RUBBLE OR OBSTRUCTIONS, REPORT TO THE LANDSCAPE ARCHITECT AND CONSTRUCTION MANAGER BEFORE PLANTING.

# 3.9) GRADING

- A) VERIFY GRADES PRIOR TO PLANTING, THE CONTRACTOR SHALL VERIFY THAT CONSTRUCTED GRADES ARE AS INDICATED ON PLANS. THE CONTRACTOR SHALL NOTIFY THE LANDSCAPE ARCHITECT IF ADJUSTMENTS TO PLANT PLACEMENT MAY BE REQUIRED DUE TO FIELD CONDITIONS AND FINAL GRADING.
- B) POSITIVE DRAINAGE SHALL BE MAINTAINED AWAY FROM AND AROUND BUILDINGS (REFER TO ENGINEERS GRADING PLANS). REPORT ANY CONFLICTS TO HAWK DESIGN, INC. PRIOR TO INSTALLATION.
- C) FINISH GRADE OF PLANTINGS SHALL BE EQUIVALENT TO FORMER EXISTING GRADE OF PLANT IN THE NURSERY.
- 3.10) BALLED AND BURLAPED (B&B) MATERIALS:
- A) CUT WIRE BASKETS ONCE IN THE PLANT PIT AND PEEL WIRE BACK.
- B) TAGS AND TWINE ARE TO BE REMOVED AND BURLAP IS TO BE ROLLED BACK ONE-THIRD ON ALL B¢B PLANT MATERIAL. ANY SYNTHETIC BURLAP SHALL BE COMPLETELY REMOVED FROM ANY PLANT MATERIAL

# Plant Installation Cont'd

- 3.11) CONTAINER GROWN STOCK: SHALL BE REMOVED FROM CONTAINER BY CUTTING CONTAINER AWAY TO AVOID ROOT DAMAGE TO PLANT ROOT SYSTEM. IF PLANT ROOT IS BOUND, SLICE ROOT BALLS APPROXIMATELY 2" DEEP WITH KNIFE OR SHARP SPADE.
- 3.12) DO NOT USE MUDDY OR FROZEN SOIL TO BACKFILL PLANTINGS.
- 3.13) WATERING: THOROUGHLY WATER UNTIL SOIL IS SATURATED AROUND ALL TREES AND SHRUBS AFTER PLANTING AND THROUGHOUT THE TIME PERIOD UNTIL FINAL ACCEPTANCE FROM CLIENT. DURING DRY CONDITIONS, WATER AS REQUIRED TO MAINTAIN PLANTS IN A WILT-FREE CONDITION.
- 3.14) PRUNING: TREES SHALL BE PRUNED TO BALANCE TOP GROWTH WITH ROOTS AND TO PRESERVE THEIR NATURAL CHARACTER AND TYPICAL GROWTH HABIT. PRUNING SHALL BE RESTRICTED IN GENERAL TO THE SECONDARY BRANCHES AND SUCKER GROWTH. ALL CUTS TO BE FLUSH WITH TRUNK. DO NOT CUT A LEADER. THE LANDSCAPE ARCHITECT WILL REJECT ALL PLANTS DISFIGURED BY POOR PRUNING PRACTICES. ALL PRUNING CUTS SHALL REMAIN UNPAINTED.
- 3.15) <u>STAKING AND GUYING</u>: ALL TREES TO BE STAKED AND GUYED WITHIN 48 HOURS OF PLANTING. METHODS AND MATERIALS FOR STAKING AND GUYING ARE ILLUSTRATED IN INDIVIDUAL PLANTING DETAILS. NEATLY FLAG ALL GUY WIRES WITH ROT RESISTANCE YELLOW TREE MARKING RIBBON.
- 3. I G) STAKE OUT PLANT LOCATIONS: PRIOR TO PLANTING THE CONTRACTOR SHALL LAYOUT THE EXTENT OF THE PLANT BEDS AND PROPOSED LOCATIONS FOR B\$B PLANTS FOR REVIEW BY THE OWNER AND LANDSCAPE ARCHITECT.
- 3.17) PLANTING FIELD ADJUSTMENTS:
- A) THE CONTACTOR IS TO SLIGHTLY ADJUST PLANT LOCATIONS IN THE FIELD AS NECESSARY TO BE CLEAR OF DRAINAGE SWALES AND UTILITES.
- B) LARGE GROWING PLANTS ARE NOT TO BE PLANTED IN FRONT OF WINDOWS OR UNDER BUILDING OVERHANGS. NOTIFY THE LANDSCAPE ARCHITECT OF DISCREPANCIES IN PLANTING PLAN VS. FIELD CONDITIONS.
- C) SHRUBS PLANTED NEAR HVAC UNITS ARE TO BE LOCATED SO THAT SHRUBS AT MATURITY WILL MAINTAIN ONE FOOT (I') AIRSPACE BETWEEN THE UNIT AND THE PLANT. ANY PLANTING SHOWN ADJACENT TO CONDENSER UNITS SHALL BE PLANTED TO SCREEN THE UNITS. SHOULD THE CONDENSER UNITS BE INSTALLED IN LOCATIONS DIFFERENT FROM THOSE SHOWN ON THE PLAN, IT WILL BE THE CONTRACTOR'S RESPONSIBILITY TO NOTIFY THE LANDSCAPE ARCHITECT AND INSTALL THE MATERIAL AROUND THE CONDENSERS AND ADJUST THE OTHER PLANTING ACCORDINGLY.
- 3.18) PLANT BED EDGES/LINES: GROUPS OF SHRUBS, PERENNIALS AND GROUNDCOVERS SHALL BE PLACED IN A CONTINUOUS MULCH BED WITH SMOOTH CONTINUOUS LINES. ALL MULCHED BED EDGES SHALL BE CURVILINEAR IN SHAPE, FOLLOWING THE CONTOUR OF THE PLANT MASS. TREES LOCATED WITHIN 4 FEET OF PLANT BEDS SHALL SHARE THE SAME MULCH BEDS.
- 3.19) A.D.A. THE AMERICAN WITH DISABILITIES ACT STANDARDS REQUIRE THAT A 7 FOOT VERTICAL CLEARANCE BE MAINTAINED FROM TREE BRANCHES TO FINISHED GRADE WHERE PEDESTRIANS SIDEWALKS AND/OR TRAILS ARE LOCATED. THE CONTRACTOR IS TO ADJUST TREE PLANTINGS IN FIELD TO SLIGHTLY MINIMIZE BRANCH OVERHANG AND COMPLY WITH THE A.D.A. ACT.
- 3.20) TREE SPACING MINUMUMS: TREES SHALL BE LOCATED A MINIMUM OF 4 FEET FROM RETAINING WALLS AND WALKS WITHIN THE PROJECT. IF A CONFLICT ARISES BETWEEN ACTUAL SIZE OF AREA AND PLANS, THE CONTRACTOR SHALL CONTACT THE LANDSCAPE ARCHITECT FOR RESOLUTION. FAILURE TO MAKE SUCH CONFLICTS KNOWN TO LANDSCAPE ARCHITECT WILL RESULT IN CONTRACTOR'S LIABILITY TO RELOCATE MATERIALS.

# **Seeding and Sodding:**

- 4.1) SEEDING OF LAWN AREAS: GRASS SEED APPLICATION SHALL BE SPREAD AT THE RATE OF 5 LBS. PER 1,000 SQUARE FEET, SEEDING SHALL BE ACCOMPLISHED BY MEANS OF A HYDRO-SEEDING PROCESS.
- 4.2) WATERING OF SEEDED AREAS: 24 HOURS AFTER HYDRO SEEDING, THE CONTRACTOR SHALL WATER THE SEEDED AREA LIGHTLY AND SUFFICIENTLY TO A DEPTH OF TWO INCHES (2") 2 TIMES A DAY (BETWEEN THE HOURS OF 7 PM AND 7 AM), UNTIL THE SEEDS ARE ESTABLISHED.
- 4.3) SEEDED AREA PROTECTION: THE CONTRACTOR SHALL ERECT SUITABLE SIGNS AND BARRICADES NOTIPYING THE PUBLIC TO KEEP OFF THE SEEDED AREAS UNTIL WELL ESTABLISHED. ANY TRAFFIC DAMAGE AND VANDALISM THAT MAY OCCUR PRIOR TO FINAL ACCEPTANCE OF THE WORK SHALL BE REPAIRED AND RESEEDED AT THE OWNER'S EXPENSE. ANY DISTURBED OR DAMAGED BY THE CONTRACTOR SHALL BE REPAIRED IN ACCORDANCE WITH THE SPECIFICATIONS AT THE CONTRACTOR'S EXPENSE.
- 4.4) LAYING OF SOD: A KENTUCKY BLUEGRASS SOD MIX BY LOCAL SOURCE AS SELECTED BY CONTRACTOR, SHALL BE FRESHLY CUT FROM THE SAME FIELD WITH 1/2 -3/4 INCHES OF SOIL. SOD SHALL BE LAID IMMEDIATELY WITH ANY STORED SOD BEING UNROLLED GRASS SIDE UP AND KEPT WATERED. LAY COURSES TIGHTLY TOGETHER WITHOUT OVERLAPPING WITH THE JOINTS STAGGERED. AFTER SODDING IS COMPLETE, ROLL LIGHTLY. THE CONTRACTOR SHALL WATER THE SODDED AREAS TO A DEPTH OF AT LEAST SIX INCHES AFTER THE SODDING PROCESS. OWNER SHALL THEN BE RESPONSIBLE FOR WATERING. THE FREQUENCY SHALL BE DETERMINED BY RAIN FALL AND WINDS WITH THE UPPER TWO OR THREE INCHES OF SOIL NOT DRYING OUT MARKEDLY.
- 4.5) SODDED AREA: INSPECTION AND ACCEPTANCE: FOUR WEEKS AFTER CONTRACTOR COMPLETES INSTALLATION, LANDSCAPE ARCHITECT SHALL INSPECT THE LAWN TO DETERMINE THE ACCEPTABILITY OF THE INSTALLATION. SODDED AREAS FAILING TO SHOW ADEQUATE ROOTING INTO THE SUBSOIL, OVERLAPPING, COURSE SEPARATION, UNEVENNESS OF THE SURFACE, UNEVEN COURSE COLOR AND EXCESSIVE BROADLEAF WEED CONTENT SHALL BE REPLACED. THE COST SHALL BE BORNE BY THE CONTRACTOR EXCEPT WHERE VANDALISM OR NEGLECT ON THE PART OF OTHERS NOT UNDER THE CONTRACTORS CONTROL HAS RESULTED IN DAMAGE.
- 4.6) FINAL APPROVAL: SEEDED AND SODDED AREAS WILL RECEIVE FINAL APPROVAL IF COVERAGE IS FULL AND CONSISTENT, FREE OF BARE SPOTS AND WEED FREE. WHEN GRASS IS CUT AT 2" HEIGHT NO SOIL SHOULD BE VISIBLE. SOD AREAS MUST HAVE RECEIVED A MINIMUM OF TWO MOWINGS. AREAS SODDED AFTER NOVEMBER I ST WILL BE ACCEPTED THE FOLLOWING SPRING ONE MONTH AFTER THE START OF THE GROWING SEASON, IF THE ABOVE CRITERIA HAS BEEN MET.

# **Maintenance:**

- 5.1) MAINTENANCE DURING INSTALLATION: MAINTENANCE OPERATIONS SHALL BEGIN IMMEDIATELY AFTER EACH PLANT IS PLANTED AND SHALL CONTINUE AS REQUIRED UNTIL FINAL ACCEPTANCE AND THEN FOR THE GUARANTEE PERIOD. PLANTS SHALL BE KEPT IN A HEALTHY, GROWING CONDITION BY WATERING, PRUNING, SPRAYING, WEEDING AND ANY OTHER NECESSARY OPERATIONS OF MAINTENANCE. PLANT SAUCERS AND BEDS SHALL BE KEPT FREE OF WEEDS, GRASS AND OTHER UNDESIRED VEGETATION. PLANTS SHALL BE INSPECTED AT LEAST ONCE PER WEEK BY THE CONTRACTOR DURING THE INSTALLATION PERIOD AND ANY NEEDED MAINTENANCE IS TO BE PERFORMED PROMPTLY.
- 5.2) GRASS AND WEED CONTROL: THE CONTRACTOR SHALL BE RESPONSIBLE FOR MOWING ALL GRASS AROUND LANDSCAPE BEDS AND INDIVIDUAL TREES AND SHRUBS UNTIL FINAL ACCEPTANCE. WEED CONTROL AREAS SHALL INCLUDE ALL LANDSCAPE BEDS AND THE AREA WITHIN 2 FEET OF THE OUTER EDGE OF THE MULCH AREA OR INDIVIDUAL TREE/SHRUBS.
- 5.3) THE CONTRACTOR SHALL WATER, FERTILIZE, WEED, CULTIVATE, REMULCH, SPRAY TO CONTROL INSECT INFESTATION AND DISEASE AND PERFORM ANY OTHER GOOD HORTICULTURAL PRACTICE NECESSARY TO MAINTAIN THE PLANTS IN A LIVING HEALTHY CONDITION UPON THE TIME FOR TERMINATION OF HIS RESPONSIBILITY FOR CARE AS SET OUT HEREIN. THE CONTRACTOR SHALL BE RESPONSIBLE FOR THE PLANTS THROUGHOUT LIFE OF THE CONTRACT.
- 5.4) ALL PLANTS STOLEN, DAMAGED OR DESTROYED BY FIRE, AUTOMOBILES, VANDALISM OR ANY OTHER CAUSE, WITH THE EXCEPTION OF PLANTS DAMAGED OR DESTROYED BY THE OWNERS MAINTENANCE OPERATIONS, SHALL BE REPLACED BY THE OWNER PRIOR TO THE DATE OF FINAL ACCEPTANCE.
- 5.5) LANDSCAPE CONTRACTOR SHALL PREPARE MAINTENANCE SPECIFICATIONS AND SCHEDULE ANNUAL CARE OF ALL PLANTED AND LAWN AREAS INCLUDING FERTILIZING, WEEDING, MULCHING, BED EDGING, PRUNING AND PEST PREVENTION AND TREATMENT.

# Plant Material Guarantee:

- \*CONTRACTOR SHALL GUARANTEE IN WRITING ALL PLANT MATERIAL AND LANDSCAPE IMPROVEMENTS FOR A PERIOD OF ONE YEAR. THE GUARANTEE IS TO INCLUDE THE FOLLOWING:
- 6.1) INSPECTIONS: PERFORM PERIODIC INSPECTIONS DURING GUARANTEE PERIOD WITH RESULTING WRITTEN REPORTS TO OWNER, PROJECT ADMINISTRATOR AND LANDSCAPE ARCHITECT STATING CONDITIONS AND RECOMMEND MAINTENANCE MODIFICATIONS. THE CONTRACTOR MUST CONTACT THE OWNER AND LANDSCAPE ARCHITECT AT LEAST 10 DAYS IN ADVANCE TO SCHEDULE ACCEPTANCE INSPECTION(S).
- 6.2) REMOVAL AND REPLACEMENT OF PLANTS PROVIDED BY CONTRACTOR TO BE DONE WITHIN THIRTY DAYS OF NOTIFICATION BY OWNER OF THEIR UNSATISFACTORY CONDITION DURING GROWING SEASONS. REPLACEMENT MATERIALS MUST BE EQUAL IN TYPE AND SIZE PER THE PROJECT'S PLANT LIST.
- 6.3) WHEN REPLACEMENT PLANT SPECIES IS EITHER NOT READILY AVAILABLE OR NO LONGER SUITABLE TO EXISTING SITE CONDITIONS WRITTEN NOTICE RECOMMENDATION OF SUBSTITUTION TO BE PROVIDED TO THE OWNER AND LANDSCAPE ARCHITECT WITHIN FIFTEEN DAYS FOR APPROVAL.
- 6.4) REMOVAL OF TREE'S SUPPORTS AND DEAD LIMBS PRIOR TO END OF GUARANTEE INSPECTION
- 6.5) CONTINUE WITH MAINTENANCE, SEE SECTION 5.0
- 6.6) GUARANTEE SHALL BEGIN UPON DATE OF FINAL ACCEPTANCE FROM OWNER AND WILL CONTINUE FOR ONE YEAR.

# Site Cleanup:

- 7.1) SITE WORK CONDITIONS: EXCESS WASTE MATERIAL SHALL BE REMOVED DAILY WHEN PLANTING IN AN AREA HAS BEEN COMPLETED, THE AREA SHALL BE CLEARED OF ALL DEBRIS, SOIL PILES AND CONTAINERS DAILY. WHERE EXISTING GRASS AREAS HAVE BEEN DAMAGED OR SCARRED DURING PLANTING OPERATIONS, THE CONTRACTOR SHALL RESTORE DISTURBED AREAS TO THEIR ORIGINAL CONDITIONS AT HIS EXPENSE.
- 7.2) CLEAN PAVED AREAS UTILIZED FOR HAULING OR EQUIPMENT STORAGE AT END OF EACH WORKDAY.
- 7.3) MAINTAIN VEHICLES AND EQUIPMENT IN CLEAN CONDITION TO PREVENT SOILING OF ROADS, WALKS OR OTHER PAVED OR SURFACED AREAS.
- 7.4) REMOVE PROTECTIVE BARRIERS AND WARNING SIGNS AT TERMINATION OF LAWN ESTABLISHMENT.



**Hawk Design, Inc.** Landscape Architecture Land Planning Sagamore, MA 508-833-8800


info@hawkdesigninc.com

IAWK DESIGN, INC. 2013

THIS DRAWING AND ALL INFORMATION CONTAINI HEREON IS PROPRIETARY INFORMATION OF HAW DESIGN, INC. AND MAY NOT BE COPIED OR REPRODUCED, EITHER IN WHOLE OR IN PART, BY ANY METHOD, WITHOUT WRITTEN PERMISSION O HAWK DESIGN, INC.

Date: 2/3/23

**Revisions:**Num. Date Description

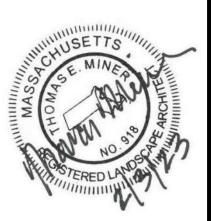

**12m** sachusetts

Wingate At Needham Highland Avenue - Needham, Massachuse

At

Planting Notes

Checked By:

et: **n**9

# SITE DEVELOPMENT PLANS

FOR

# WINGATE AT NEEDHAM, INC 589 HIGHLAND AVENUE NEEDHAM, MA

FEBRUARY 03, 2023

SHEET INDEX									
SHEET NO	DESCRIPTION		LATEST	REVISED	DATE	CONST	RUCTIO	N REV	ISIONS
1	COVER SHEET								
2	EXISTING CONDITIONS PLAN								
3	LAYOUT PLAN								



LOCATION MAP

# OWNER:

WINGATE AT NEEDHAM, INC 63 KENDRICK STREET NEEDHAM, MA 02494

# APPLICANT:

WINGATE DEVELOPMENT LLC 63 KENDRICK STREET NEEDHAM, MA 02494

# CIVIL ENGINEER:

KELLY ENGINEERING GROUP, INC. O CAMPANELLI DRIVE BRAINTREE, MA 02184

# LAND SURVEYOR:

R.E. CAMERON & ASSOCIATES, INC. 681 WASHINGTON ST. NORWOOD, MA 02062

# ARCHITECT:

THE ARCHITECTURAL TEAM 50 COMMANDANTS WAY CHELSEA, MA 02150


# LANDSCAPE ARCHITECT:

HAWK DESIGN INC. P.O. BOX 1309 SANDWICH, MA 02563


# TRAFFIC CONSULTANT:


RON MUELLER & ASSOCIATES 56 TERESA ROAD HOPKINTON, MA 01748

Brandon Li 16:45:17

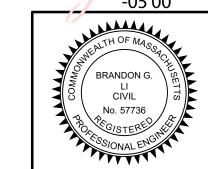

	SCALE NA	JOB # 2022–164				
	DATE 02/03/23	DRAWN BY CJL				
	SHEET 1 of 3	CHKD BY DAM				
	FILE #	APPD BY				

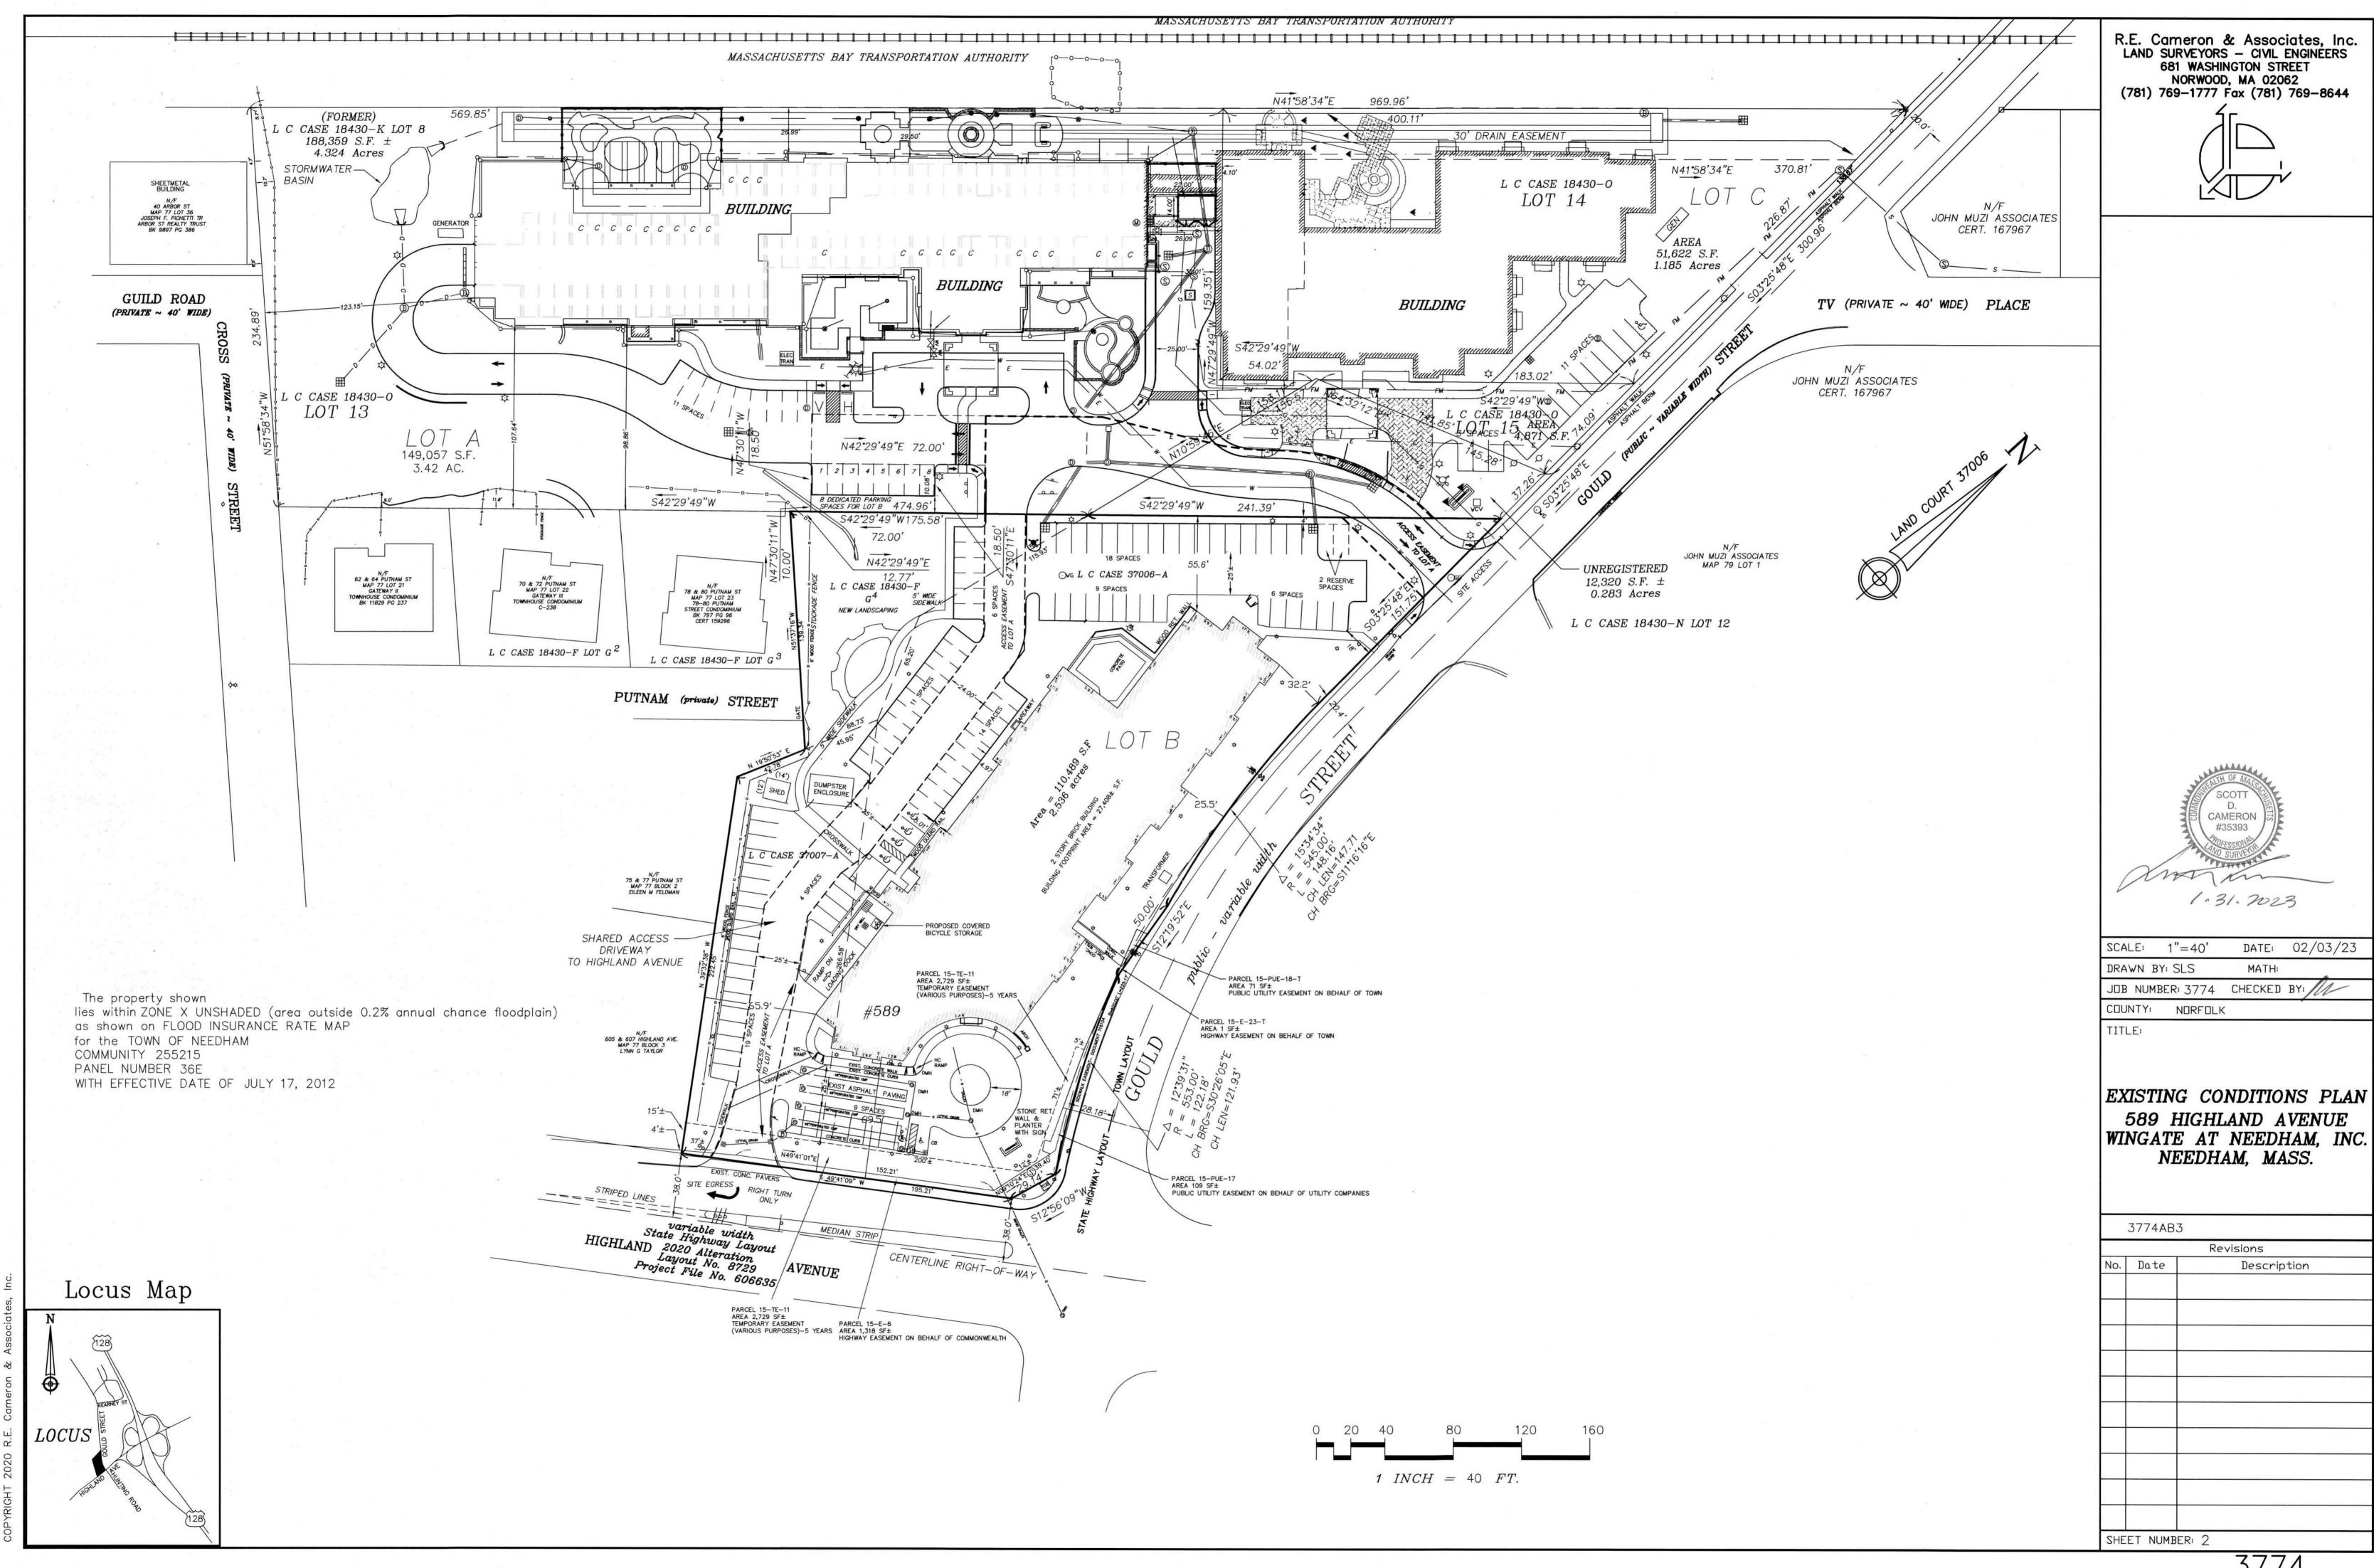

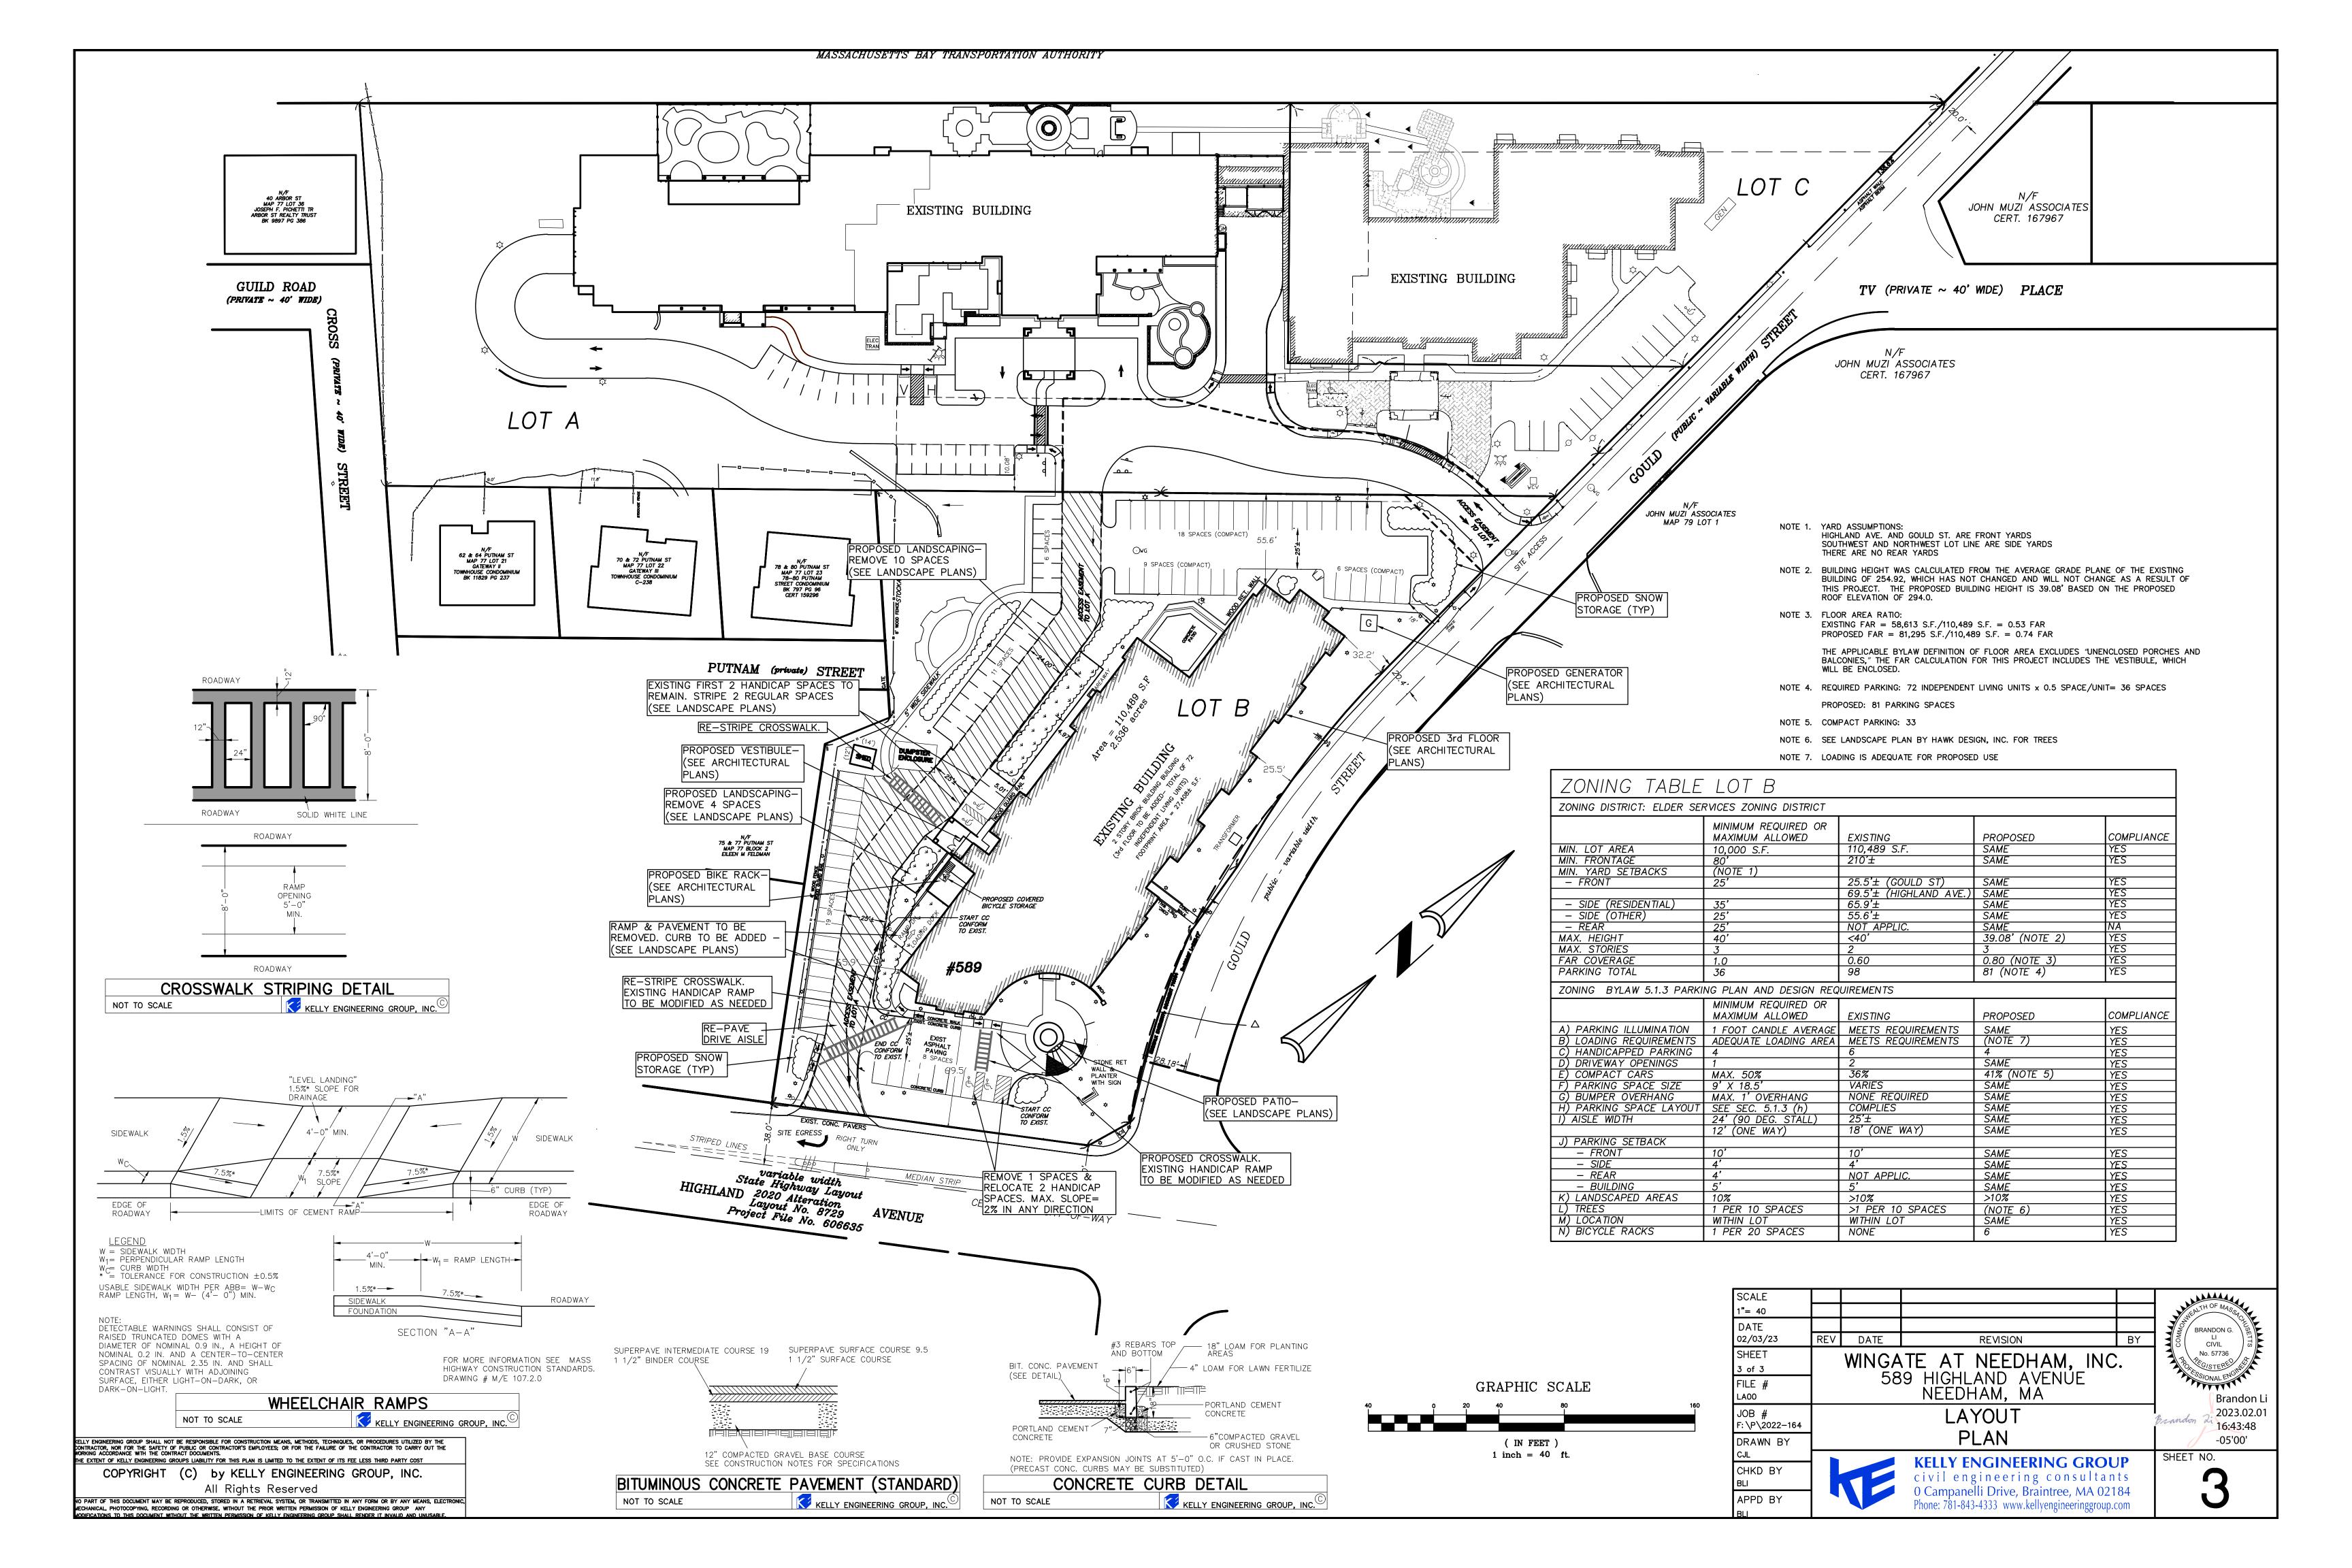

# STORMWATER MANAGEMENT REPORT 02/03/2023

# WINGATE AT NEEDHAM, INC 589 HIGHLAND AVENUE NEEDHAM, MA

PREPARED FOR:

# WINGATE AT NEEDHAM, INC 63 KENDRICK STREET NEEDHAM, MA 02494



Brandon 2

Brandon Li 2023.01.31 18:00:29 -05'00'



PREPARED BY:



KELLY ENGINEERING GROUP

civil engineering consultants O Campanelli Drive, Braintree, MA 02184 Phone: 781-843-4333 www.kellyengineeringgroup.com

# TABLE OF CONTENTS

Stormwater Letter

Stormwater Maintenance System Operation and Maintenance Plan & Long Term Pollution Prevention Plan

NPDES Requirements for Public Outreach Letter



February 03, 2023

Town of Needham Planning Board 500 Dedham Ave. Needham MA 02492 Attn: Lee Newman

Cc: David Feldman - Continental Wingate

Tom Ryder – Department of Public Works

Re: Stormwater

Special Permit & Site Plan Review Wingate at Needham, Inc 589 Highland Avenue Needham, MA

Dear Members of the Board:

The existing site is serviced by a fully developed storm drainage system as shown on the existing conditions plan provided with this application. We have consulted with site maintenance personnel and are not aware of any drainage issues on the property. The Needham Stormwater Bylaw Article 7 is not applicable to the proposed project. There is no increase to the existing building footprint. The renovations and floor areas in building are not increasing the footprint of the building. There is a reduction of 6,410 s.f. in impervious parking area. The existing impervious area of 71,353 s.f. will be reduced by removing 14 parking space and replace them with landscaping. This makes the proposed impervious area 64,943 s.f. and therefore exempt from the Needham Stormwater Bylaw. Façade treatments, interior renovations, and less than 1,500 s.f. increase in parking area are exempt under section 7.4.2 of the Stormwater Bylaw.

As part of the Town of Needham DPW NPDES requirements, the applicant will comply with the Public Out Reach & Education and Public Participation & Involvement control measures. Attached is a letter to the DPW identifying the measures selected and dates by which the measures will be completed in order to incorporate it into the Planning Board's decision.

We look forward to presenting this project to you at your next scheduled meeting. If you have any questions or desire any additional information regarding this matter, please do not hesitate to call our office.

Sincerely,

KELLY ENGINEERING GROUP, INC.

Brandon Li Brandon 2: 2023.01.31 18:00:45 -05'00'

Brandon G. Li. P.E. Senior Engineer

# WINGATE AT NEEDHAM, INC 589 HIGHLAND AVENUE NEEDHAM, MA

# STORMWATER MANAGEMENT SYSTEM OPERATION AND MAINTENANCE PLAN & LONG-TERM POLLUTION PREVENTION PLAN

02/03/2023

Prepared by:

## KELLY ENGINEERING GROUP, INC.

Zero Campanelli Drive Braintree, Massachusetts 02184

OWNER:

Wingate at Needham, Inc. 63 Kendrick Street Needham, MA 02494

APPLICANT AND RESPONSIBLE PARTY:

Wingate Development, LLC

63 Kendrick Street Needham, MA 02494

David Feldman

Note: If ownership of this property changes then the new owner becomes the responsible party.

The Owner may assign responsibility to a tenant on the property.

### Introduction

The stormwater management system consists of a number of Best Management Practices (BMP's). These BMP's combine to ensure that storm runoff from the site will not damage the sensitive environmental resources surrounding the site. In order to ensure that these BMP's operate as designed it is very important that the procedures in this operation and maintenance plan be followed. Most of these operation procedures require observation and measurement; however, at certain times more extensive maintenance measures may be needed. The following is an itemization of each of these BMP's and their maintenance needs.

The party responsible for maintenance should contract with a maintenance organization capable of performing the more extensive measures such as pumping of catch basin sumps, etc.

## BMP No. 1 - Paved Road Surface:

- Regularly pick up and remove litter from the paved road surface and landscaped areas.
- The paved area is to be swept on a quarterly average, with sweeping scheduled primarily in spring and fall with a high efficiency vacuum sweeper or a regenerative air sweeper. If a mechanical sweeper is used, the paved area is to be swept on a monthly average.

#### BMP No. 2 - Deep Sump Catch Basins:

- Basins are to be inspected 4 times per year.
  - 1. Verify that tees are secure and free-flowing.
  - 2. Measure depth of sediment below water line.
- Basins are to be cleaned whenever sediment and hydrocarbons are observed. Basins are to be cleaned a minimum of twice per year. One of these cleanings shall occur before April 15<sup>th</sup> of each year and one shall occur before September 15<sup>th</sup> of each year. Basins may be cleaned either using a clamshell or a vacuum pump.
- All liquid shall be pumped from the sump of each basin at least once per year.
- All sediments and hydrocarbons should be properly handled and disposed of, in accordance with local, state and federal guidelines and regulations.

Note: See catch basin detail for explanation of terms.

#### BMP No. 4 - Subsurface Recharge Systems:

- The inlet pipe and observation basin shall be inspected 4 times a year. Any accumulated debris shall be removed.
- Inspect recharge facilities following a rainfall event greater than 2.5 inches in a 24 hour period.
- If standing water is observed for more than 48 hours following a storm event, immediately retain a qualified professional to assess whether infiltration function has been lost and develop recommended corrective actions.

#### Snow Removal:

- Road salts and de-icing materials shall be stored on impervious pads and covered to protect from wind and precipitation.
- There shall be no plowing or stock piling of snow within any resource areas and any area subject to the jurisdiction of local and state regulations without the prior written permission from state or local approving authority.
- No de-icing materials shall be stored nor used within all resource areas and any area subject to the
  jurisdiction of local and state regulations without the prior written permission from state or local
  approving authority.

### Storage and Use of Chemicals:

- No pesticides, herbicides, nor insecticides shall be stored nor used within all resource areas and any area subject to the jurisdiction of local and state regulations without the prior written permission from state or local approving authority.
- Chemical storage on site shall be limited. Any chemicals that must be stored shall be stored in a secure area in accordance with Local and State regulations.

#### Hazardous Waste:

- Containment In the event of a discharge or spill of oil or another hazardous material, outlets to stormwater management ponds shall be plugged so that hazardous material do not enter resource areas.
- Reporting In the event of a discharge or spill of oil or another hazardous material, responsible facility
  personnel, oil spill and/or hazardous material removal organizations, federal, state, and local regulatory
  agencies, the Town of Needham Department of Public Works, and the EPA National Response Center
  1-800-424-8802 shall be rapidly notified.
- Hazardous Waste All hazardous waste materials will be disposed of in the manner specified by local, state and/or federal regulations and by the manufacturer of such products.
- There shall be no illicit discharges to the stormwater management system.

## Training for Long Term Pollution Prevention Plan:

All staff or personnel involved and responsible for implementing the Stormwater Management System
Operations and Maintenance Plan and the Long-Term Pollution Prevention Plan shall be properly
trained as required under the DEP Stormwater Management Regulations. Training shall be
documented with records kept with other stormwater maintenance records.

#### Pet Waste Management:

- Pooper-scooper laws for pets shall be followed.
- Never dump pet waste into storm drains, catch basins, or the drainage system.
- Pet waste shall be scooped up and disposed of properly in the garbage.

#### Lawn and Garden activities:

No pesticides, herbicides, nor insecticides shall be stored nor used within any resource areas its buffers, and any area subject to the jurisdiction of local and state regulations without the prior written

permission from state or local approving authority.

• Fertilizers and pesticides shall be applied properly, sparingly, and outside any resource areas and its buffers.

To reduce the impact of fertilizers, consider the following tips;

- Don't fertilize before a rain storm.
- Consider using organic fertilizers. They release nutrients more slowly.
- Test soils before applying fertilizers. Some soils may not need fertilizers. A standard soil test costs \$9.00. (Call the UMass Extension Soil Testing Lab at 413-545-2311 or download a soil test order form at <a href="http://www.umass.edu/plsoils/soiltest/">http://www.umass.edu/plsoils/soiltest/</a>.)

February 03, 2023

Needham Planning Board Needham Town Hall 500 Dedham Avenue Needham, MA 02492 Attention: Lee Newman

RE: NPDES requirements

Wingate at Needham, Inc 589 Highland Avenue

Needham, MA

Dear Members of the Board,

As part of the NPDES requirement for Control Measure #1: Public Education and Outreach, the applicant will place an advertisement in the local newspaper to encourage environmental awareness. This advertisement will be published prior to occupancy of the building.

As part of the NPDES requirement for Control Measure #2: Public Participation and Involvement, the catch basins will include a plaque with the words "NO DUMPING - DRAINS TO RIVER" by Almetek. These plaques will be installed at prior to occupancy of the building.

If you have any questions, please contact me.

Sincerely,

David Feldman